


Communication Site Development 26 DEAD TREE RUN ROAD, MONTGOMERY TWP, SOMERSET COUNTY, NEW JERSEY 08502 BLOCK: 17001 LOT: 11.02

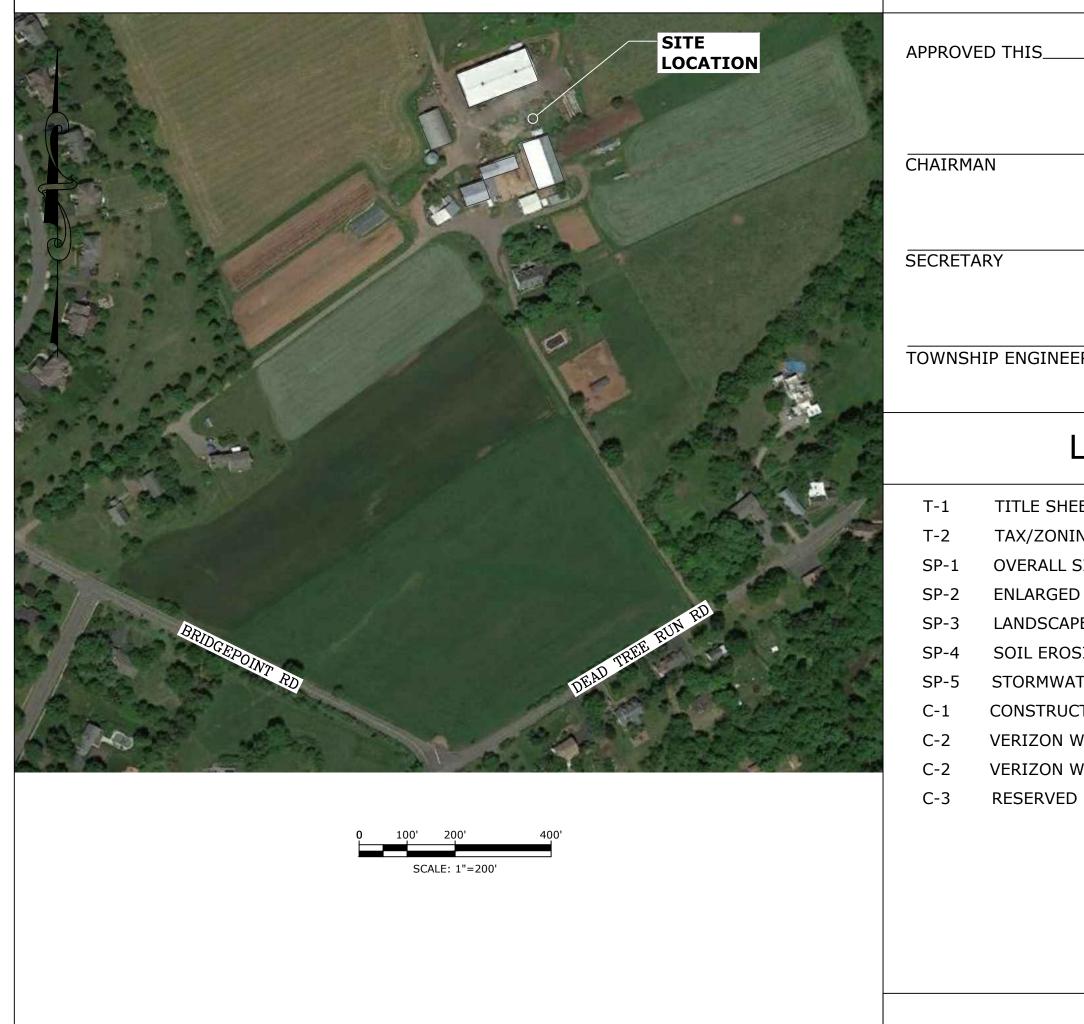



		SCHEDULE OF REVISIONS		
0	01/23/20	ISSUED FOR MUNICIPAL REVIEW	TR	JS
REV. NO.	DATE	DESCRIPTION OF CHANGES	DRAWN BY	CHK BY

NEW YORK SMSA LIMITED PARTNERSHIP **d/b/a** verizon wireless


TOWNSHIP APPROVAL			BULK	REQUIREMEN	ITS
	ZONE: R2	2 - SINGLE	FAMILY RESIDE	NTIAL - PROPOSED USE: T	ELECOMM
IS DAY OF ZO IS DAY OF ZO MINIMUM LOT AREA MINIMUM LOT AREA MINIMUM LOT VIDT MINIMUM LOT DEPTI MINIMUM LOT FROM MINIMUM LOT CROM MINIMUM LOT FROM MINIMUM LOT CROM MINIMUM SIDE (EAS MINIMUM SIDE (EAS MINIMUM SIDE (EAS MINIMUM REAR LOT (IMPERVIOUS) (INTROPORTY DEPTION MINIMUM REAR LOT (IMPERVIOUS) (INTROPORTY DEVINER LIST DISTANCE TO SIDE E SHEET DISTANCE TO THEI ZONING MAP & 200' PROPERTY OWNER LIST DISTANCE TO OTHEI RALL SITE PLAN ACCESSORY BUILDI ARGED SITE PLAN AND ELEVATION DISCAPE PLAN L EROSION AND SEDIMENT CONTROL PLAN MAXIMUMS RMWATER PLAN AND DETAILS MINIMORY BUILDING COVERAGE PULLIDING PULLIDING COVERAGE PULLID			ORDINANCE	EXISTING	
	MINIMUM LOT AREA		2 ACRES	73.97 ACRES (3,222,322 S.F.) NC
	MINIMUM LOT WIDTH		200 FT	670.4 FT	NC
	MINIMUM LOT DEPTH		300 FT	2612 FT	NC
	MINIMUM LOT FRONTAGE		200 FT	912.44 FT	NC
	MINIMUM FRONT YARD		75 FT	708.4 FT	NC
	MINIMUM SIDE (EAST)		40 FT	411.1FT	NC
	MINIMUM SIDE (WEST)		40 FT	317.2FT	NC
GINEER	MINIMUM REAR		75 FT	1608.6 FT	NC
	LOT (IMPERVIOUS) COVERA	GE	15%	3 % (99,224 S.F.)	.0004%
	ACCESSORY BUILDING MIN	IMUM:			
LIST OF DRAWINGS	DISTANCE TO SIDE LINE		30 FT	200.1 FT	NC
E SHEET	DISTANCE TO REAR LINE		30 FT	1204.9 FT	TELECOMM S.F.) NC S.F.) NC NC NC VARIENCE VARIENCE
ZONING MAP & 200' PROPERTY OWNER LIST	DISTANCE TO OTHER BUILD	DING	20 FT	100.5 FT	NC
-	MAXIMUMS				DUSE: TELECOMM G USE: TELECOMM G G USE: TELECOMM G G C S C C C C C C C C C C C C C C C C
	BUILDING COVERAGE OF PRINCIPA	AL BUILDING	10%	0.0009% (RESIDENCE)	NC
	AGGREGATE BUILDING COVERAGE ACCESSORY BUILDING(S)	OF	3%	0.10% (BARNS & COOPS)	NC
STRUCTION DETAILS	TABLE KEY:	NC	NO CHANGE	NA NOT APPLICABLE 🛛 🔍	VARIENCE
-	WIRELESS	TELECOMM	UNICATION FACILIT	IES - SECTION 16-6.1 BASED OF	N SECOND P
-	LAND AREA (S.F.)		20,000	3,222,322	NC
ERVED SPRINT ANTENNA AND EQUIPMENT DETAILS	SETBACKS (FT):				
	STREET LINE (FT)		100	NA	1247
	LOT LINE (FT)		200	NA	524.
	RESIDENTIAL DWELLING (F	Т)	500	NA	714
	RESIDENTIAL DISTRICT BOU	NDARY (FT)	750	NA	0 F
	HISTORIC SITE OR DISTRIC	CT (FT)	1000	NA	0 F
	TOWER HIGHT (FT)(MULTIP	LE USERS)	135	NA	135 F
	PROPOSED EQUIPMENT: MAX. HEIGHT (FT)		15 FT	NA	10 F
			375		
		N.J. ENGINEERING (AUTHORIZATION No		· · · · · · · · · · · · · · · · · · ·	
"Bridging the Gaps in Service"	<i>d/b/a</i> Verizon wireless 180 WASHINGTON VALLEY ROAD, BEDMINSTER, NEW JERSEY 07921	87 HIBER ROCKAW/ PHONE: (NIA AVENUE AY, N.J. 07866 973) 299-5200 3) 299-5059	NAGEMENT LLC	Jer
SI S S. JEFFERSON ROAD SUITE M WHIPPANY. NJ 07961		CONSTRUCTION I ACT OF 1970 AND DESIGN FEATURE LLC AND SHALL I	MUST BE DONE IN COMPLIANCE WITH O ALL RULES AND REGULATIONS THER SOR CONSTRUCTION DISCLOSED AR NOT BE REPRODUCED, ALTERED OR C	PONENTS FOR CONSTRUCTION SAFETY. ALL THE OCCUPATIONAL SAFETY AND HEALTH RETO APPURTENANT. THIS DRAWING AND THE E PROPRIETARY TO E2 PROJECT MANAGEMENT OPIED WITHOUT WRITTEN PERMISSION, SHALL NTEREST AND SHALL BE RETURNED UPON REQUEST.	

	P	ROJECT DATA
MUNICATION TOWER	PROJECT:	SECTORSITE NJ-0418B
PROPOSED	LOCATION:	26 DEAD TREE RUN ROAD MONTGOMERY TWP, SOMERSET COUNTY, NEW JERSEY 08502
	LOT: BLOCK: ZONE:	11.02 17001 R-2 SINGLE FAMILY RESIDENTIAL
	PROPERTY OWNER:	JOHN & CHARLOTTE JOHNSON 26 DEAD TREE RUN ROAD BELLE MEAD, NJ 08502
	APPLICANT:	SECTORSITE, LLC 53 S. JEFFERSON ROAD, SUITE M WHIPPANY, NEW JERSEY 07981
% (1,165 S.F.) TOTAL 3% (100	CONTACT :	DAN GECHTMAN (201) 650-0988
	CO-APPLICANT:	NEW YORK SMSA LIMITED PARTNERSHIP d/b/a VERIZON WIRELESS 180 WASHINGTON VALLEY ROAD, BEDMINSTER, NEW JERSEY 07921
	CONTACT:	(908) 256-7000
(1) PRE-EXISTING NON-COM PRIORITY LOCATIONS		
	G	ENERAL NOTES
47.3		TY IS UNMANNED, OCCUPANCY IS LIMITED TO ERIZON PERSONNEL FOR ROUTINE MAINTENANCE
24.1	AND INSPECTION APPR	OXIMATELY ONCE OR TWICE A MONTH IN A
14.5 (OFF-SITE)	PASSENGER VEHICLE C PROPOSED.	OR VAN THEREFORE NO NEW PARKING IS
FT (V) (SITE)		SANITARY SEWER SERVICES ARE NOT REQUIRED E NEW COMMUNICATIONS FACILITY.
FT (V) (SITE)		ROVIDED FOR INFORMATIONAL & SAFETY
5 FT (140' TO TOP OF BRANCHI	PURPOSE ONLY. NG) 4. THE PROPOSED PROJECT	CT DOES NOT PRODUCE EXCESSIVE NOISE,
FT TO CABLE BRIDGE	GLARE, AIR POLLUTION	OR FIRE HAZARDS.
5 SF (VERIZON EQUIPMENT AR		IS PROPOSED FOR THIS PROJECT. AS ONE 60 ATED LIGHT ON TIMER SWITCH IS PROPOSED.
THAT THESE PLANS HAVE BEEN		DRAWING ISSUE STATUS CURRENTLY -
ED UNDER MY SUPERVISION	TITLE SHEET	A-ISSUED FOR PRELIMINARY REVIEW B-(SPECIFY) C-(SPECIFY) D-(SPECIFY)
1 /29/20	SITE NAME: SECTORSITE NJ-0418B	FIRST ISSUE: 11/11/19 DRAWING NO. DRAWN BY: TR T-1 CHECKED BY: JCM
JRAWSKI P.E. NJ24GE04738200	MONTGOMERY TWP, SOMERSET C NEW JERSEY 08502	PROJECT #: P-19-59-001.1 PRINT DATE: 01/23/20
ED PROFESSIONAL ENGINEER	BLOCK 17001 , LOT 11.02	FILE: C:\USERS\JIM\APPDATA\LOCAL\TEMP\ACPUBLISH_15376\ SECTORSITE NJ-418B ZD REV 0.DWG

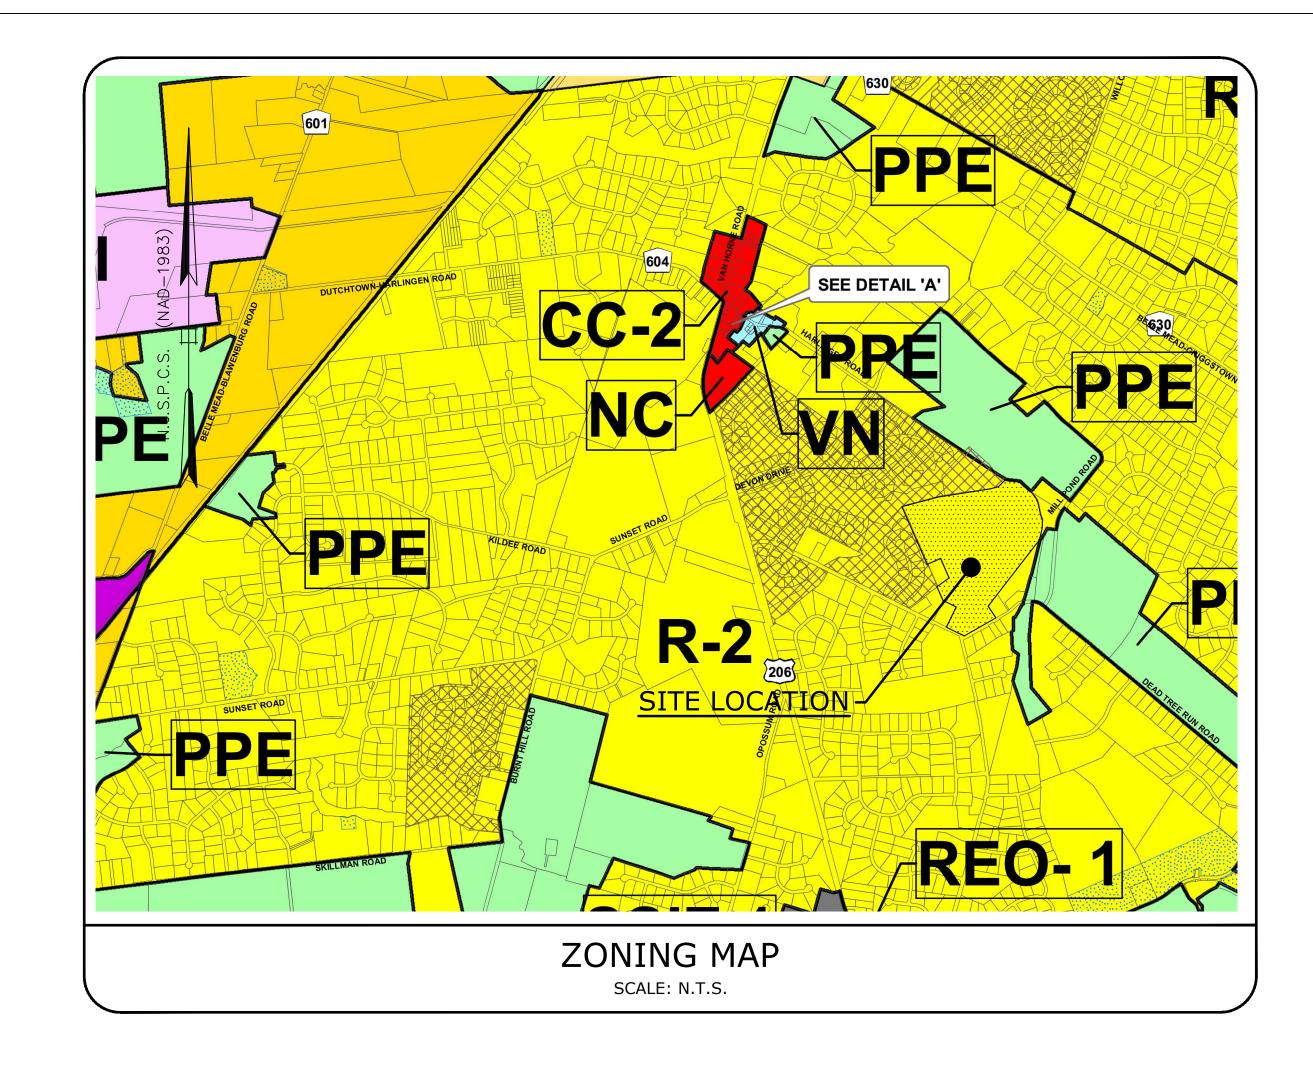

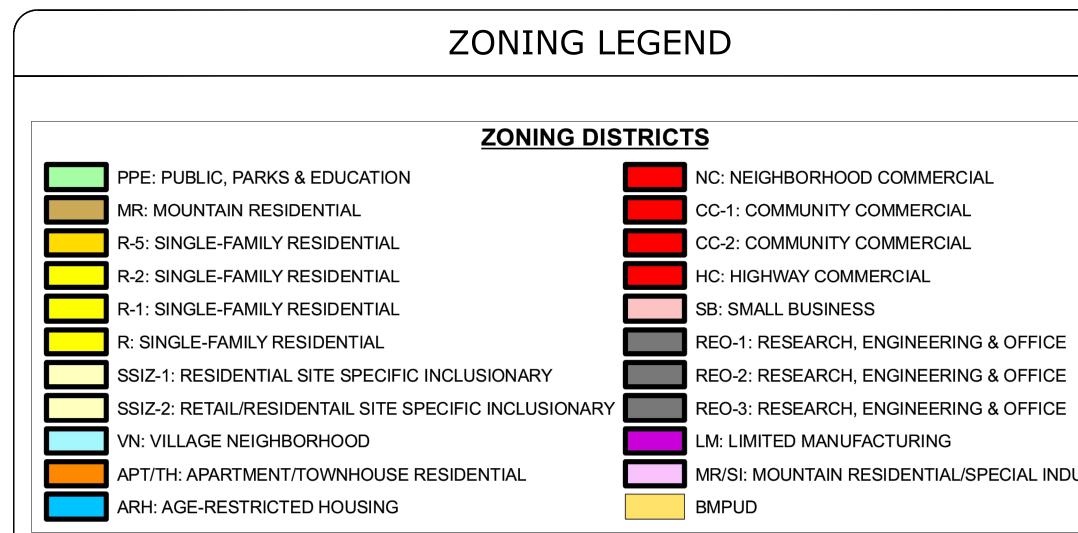

		SCHEDULE OF REVISIONS		
0	01/23/20	ISSUED FOR MUNICIPAL REVIEW	TR	JS
REV. NO.	DATE	DESCRIPTION OF CHANGES	DRAWN BY	CHK. BY
•	•			-

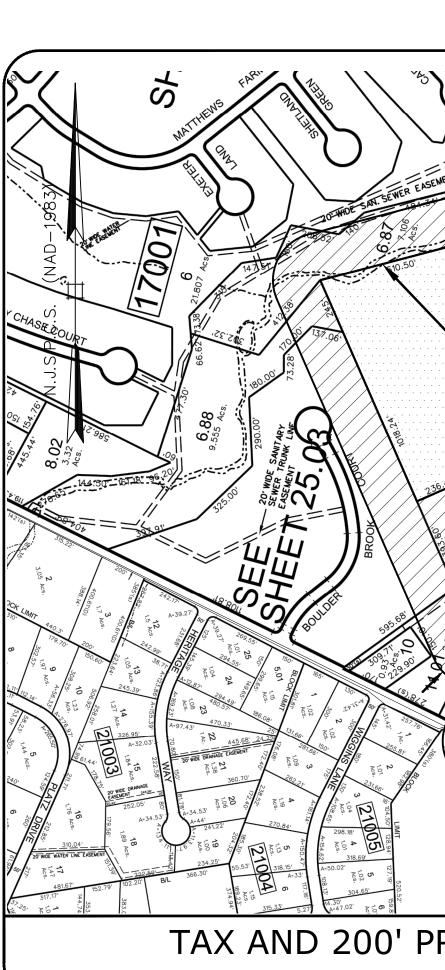

			200' P	RO
PROPERTY II	PROPERTY LOCATION	CLASS	OWNERS NAME & ADDRESS	
17001 6	HARLINGEN ROAD	1	KINGS CROSSING HOMEOWNERS 73 BRUNSWICK WOODS DRIVE EAST BRUNSWICK NJ	ASSCO 08816
17001 6.73	21 BOULDER BROOK COURT	2	LI, CHARLES & CHEN, HUIHON 21 BOULDER BROOK COURT BELLE MEAD, NJ	IG 08502
17001 6.74	20 BOULDER BROOK COURT	2	RANDOLPH, WILLIAM S. & NAN 20 BOULDER BROOK COURT BELLE MEAD, NJ	ICY F. 08502
17001 6.75	18 BOULDER BROOK COURT	2	MA, YUBIN & CHANG, ZUOYANG 18 BOULDER BROOK COURT BELLE MEAD,NJ	08502
17001 6.76	16 BOULDER BROOK COURT	2	DELACRUZ, ERNEST J. & VICK 16 BOULDER BROOK CT. BELLE MEAD, NJ	ПЕ Н. 08502
17001 6.77	14 BOULDER BROOK COURT	2	GALVIN, KATHERINE M. & MAT 14 BOULDER BROOK COURT BELLE MEAD, NJ	THEW D. 08502
17001 6.78	12 BOULDER BROOK COURT	2	GADDAM, SURESH & MARGAM VE 12 BOULDER BROOK COURT BELLE MEAD, NJ	ENA 08502
17001 6.79	10 BOULDER BROOK COURT	2	WOLTERS, WILLEM F. & ZHUGE 10 BOULDER BROOK COURT BELLE MEAD, NJ	, QING 08502
17001 6.86	31 CAROUSEL CHASE	15C	TOWNSHIP OF MONTGOMERY 2261 ROUTE 206 BELLE MEAD, NJ	08502
17001 6.87	MATTHEWS FARM ROAD REAR	15C	TOWNSHIP OF MONTGOMERY 2261 ROUTE 206 BELLE MEAD, NJ	08502
17001 6.88	BRIDGEPOINT ROAD	15C	TOWNSHIP OF MONTGOMERY 2261 ROUTE 206 BELLE MEAD, NJ	08502
17001 6.89	BRIDGEPOINT ROAD	1	KINGS CROSSING HOMEOWNERS 73 BRUNSWICK WOODS DR. EAST BRUNSWICK NJ	ASSOC 08816
17001 7	HARLINGEN ROAD	15C	TOWNSHIP OF MONTGOMERY 2261 ROUTE 206 BELLE MEAD, NJ	08502
17001 11.01	301 BRIDGEPOINT ROAD	2	JOHNSON, JOHN ALLAN & DEBO 301 BRIDGEPOINT ROAD BELLE MEAD NJ	08502
17001 11.03 QFARM	DEAD TREE RUN ROAD	3B	JOHNSON, JOHN & CHARLOTTE 26 DEAD TREE RUN BELLE MEAD, NJ	08502
17001 11.04 QFARM	DEAD TREE RUN ROAD	3B	JOHNSON, JOHN & CHARLOTTE 26 DEAD TREE RUN BELLE MEAD, NJ	08502
17001 12	36 DEAD TREE RUN ROAD	2	GULLIAUME, KEITH A. & WANG 36 DEAD TREE ROAD BELLE MEAD, NJ	, LAURA 08502
17001 14	MILL POND ROAD	15C	TOWNSHIP OF MONTGOMERY 2261 ROUTE 206 BELLE MEAD, NJ	08502

N.J. ENGINEERING CERTIFICATE OF I CERTIFY T NEW YORK SMSA AUTHORIZATION No. 24GA28118200 PREPARE LIMITED PARTNERSHIP E 2 PROJECT MANAGEMENT LLC d/b/a **verizon** wireless SECTORSITE 180 WASHINGTON VALLEY ROAD, 87 HIBERNIA AVENUE ROCKAWAY, N.J. 07866 E2PM BEDMINSTER, NEW JERSEY 07921 XV PHONE: (973) 299-5200 FAX: (973) 299-5059 "Bridging the Gaps in Service" www.E2PM.com 59 S. JEFFERSON ROAD THIS DRAWING DOES NOT INCLUDE NECESSARY COMPONENTS FOR CONSTRUCTION SAFETY. ALL CONSTRUCTION MUST BE DONE IN COMPLIANCE WITH THE OCCUPATIONAL SAFETY AND HEALTH ACT OF 1970 AND ALL RULES AND REGULATIONS THERETO APPURTENANT. THIS DRAWING AND THE DESIGN FEATURES OR CONSTRUCTION DISCLOSED ARE PROPRIETARY TO E2 PROJECT MANAGEMENT LLC AND SHALL NOT BE REPRODUCED, ALTERED OR COPIED WITHOUT WRITTEN PERMISSION, SHALL NOT BE USED IN ANY MANNER DETRIMENTAL TO ITS INTEREST AND SHALL BE RETURNED UPON REQUEST. SUITE M WHIPPANY, NJ 07961 JAMES C MU JS REGISTERE

MR/SI: MOUNTAIN RESIDENTIAL/SPECIAL INDUSTRIAL

15 17001 32 17001 35 17001 MIL 17001 MIL 17001 MIL 17001 255 21007 256 QFARM 22001 255 1.01 3 D 22001 1.02 19 22001 2 23 22001 2 23 22001 27	Theres map	
THAT THESE PLANS HAVE BEEN RED UNDER MY SUPERVISION Management 1/29/20 URAWSKI P.E. NJ24GE04738200	TAX MAP, ZONING MAP, PROPERTY OWNERS MAP AND LIST SITE NAME: SECTORSITE NJ-0418B 26 DEAD TREE RUN ROAD MONTGOMERY TWP, SOMERSET COUNTY, NEW JERSEY 08502	DRAWING ISSUE STATUS CURRENTLY - A-ISSUED FOR PRELIMINARY REVIEW B-(SPECIFY)C-(SPECIFY)D-(SPECIFY)D-(SPECIFY)DRAWING NO. FIRST ISSUE: 11/11/19 DRAWING NO. DRAWN BY: TR T2 CHECKED BY: JCM SHEET NO: 2 OF 11 PROJECT #: P-19-59-001.1 PRINT DATE: 01/23/20
RED PROFESSIONAL ENGINEER	BLOCK 17001 , LOT 11.02	FILE: C:\USERS\JIM\APPDATA\LOCAL\TEMP\ACPUBLISH_15376\ SECTORSITE NJ-418B ZD REV 0.DWG

LEGEND

--x---x---x---- PROPOSED FENCE

AREA AND IMPERVIOUS SURFACE TABLE LOT 11.02, TOTAL AREA 3,222,322 SQ. FT. TOTAL IMPERVIOUS SURFACES EXISTING BUILDINGS AT GRADE GRAVEL DRIVEWAYS

99,224 SQ. FT. (3%) 32,987 SQ. FT. (1%) 66,237 SQ. FT. (2%)

PROPERTY LINE

EASEMENT LIMIT

EXISTING CONTOUR LINE


SETBACK LINE

EXISTING FENCE

PROPOSED TOWER WIRELESS FACILITY TOTAL 1,800 SQ.FT. (< .1%) (1,165 SQ.FT. NEW) IMPERVIOUS


	SCHEDULE OF REVISIONS			
0	01/23/20	ISSUED FOR MUNICIPAL REVIEW	TR	JS
REV. NO.	DATE	DESCRIPTION OF CHANGES	DRAWN BY	CHK. BY

I.P. FND. LOT 6.88 LOT 6.89 LOT 6.74 LOT 6.73 LOT 6.75 LOT 6.76 LOT 6.82 EXISTING 24.99' WIDE COMMON ACCESS FROM LOT 11.01 TO LOT 10 AS CITED IN DEED BOOK 1908, PAGE 261 N 63°37'01" ₩_____ 28.30' (I_& E.) BLOCK 27004 { } } LOT 3

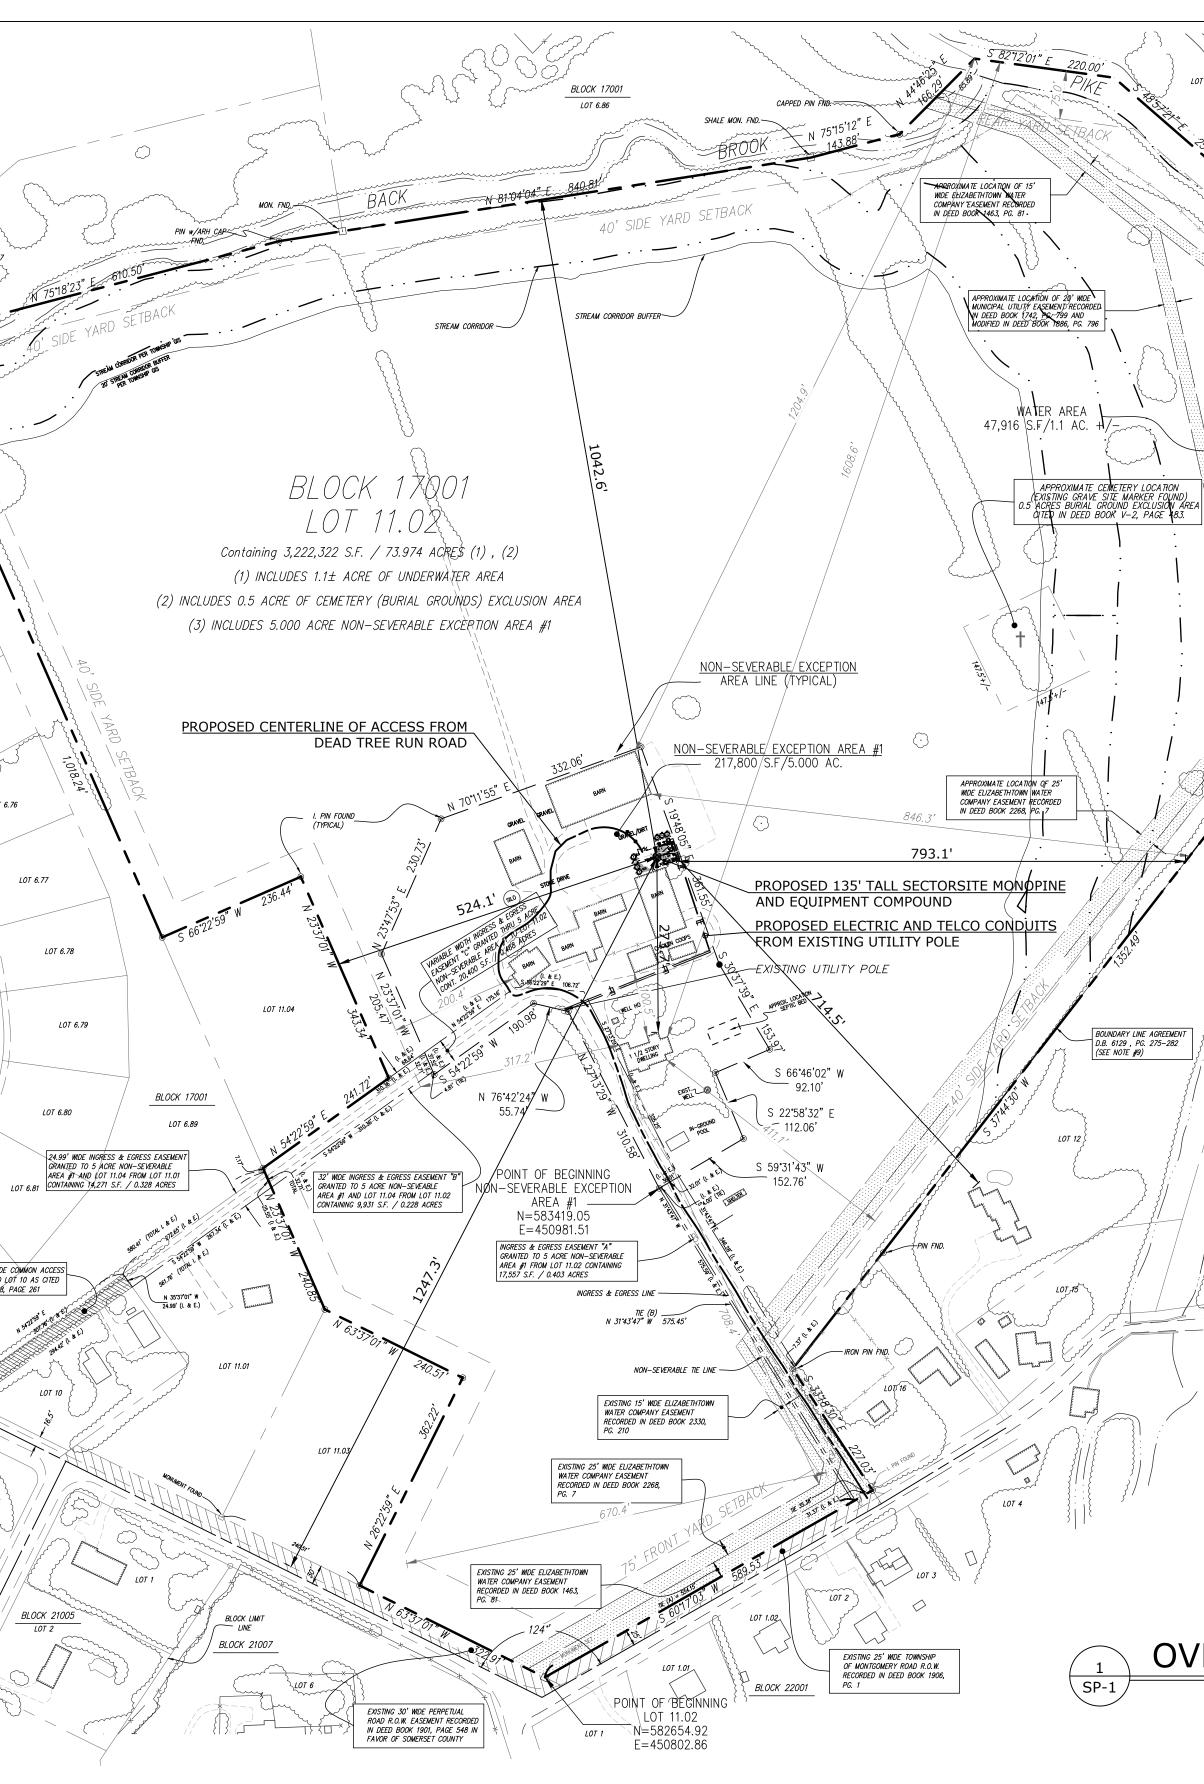



077 38 00-	John Marken John John John John John John John Joh	
BROOK S 1153'41" BROOK		
	APPROXIMATE LOCATION OF 15' WIDE ELIZABETHTOWN WATER	
	COMPANY EASEMENT RECORDED IN DEED BOOK 1745, PG. 239	
ERALL SITE		
0 25' 50' 10 SCALE: 1"=50'	0' SITE PLAN INFORMATION WAS OF 17001, LOT 11.02, MONTGOMERY	TREFERENCE: BTAINED FROM "BOUNDARY SURVEY OF BLOCK TOWNSHIP, SOMERSET COUNTY, NEW JERSEY" RING ASSOCIATES, DATED 10/17/19
THAT THESE PLANS HAVE BEEN ED UNDER MY SUPERVISION	OVERALL SITE PLAN	DRAWING ISSUE STATUS CURRENTLY - A-ISSUED FOR PRELIMINARY REVIEW B-(SPECIFY) C-(SPECIFY) D-(SPECIFY)
1 /29/20	SITE NAME: SECTORSITE NJ-0418B	FIRST ISSUE: 11/11/19 DRAWING NO. DRAWN BY: TR SP-1
JRAWSKI P.E. NJ24GE04738200 ED PROFESSIONAL ENGINEER	26 DEAD TREE RUN ROAD MONTGOMERY TWP, SOMERSET COUNTY, NEW JERSEY 08502 BLOCK 17001 , LOT 11.02	CHECKED BY: JCM SCALE: AS SHOWN SHEET NO: 3 OF 11 PROJECT #: P-19-59-001.1 PRINT DATE: 01/23/20 FILE: C: SUMAPPDATA/LOCAL/TEMP/ACPUBLISH_15376\ SECTORSITE NJ-418B ZD REV 0.DWG
		• ▲ LL • SECTORSITE NJ-418B ZD REV 0.DWG

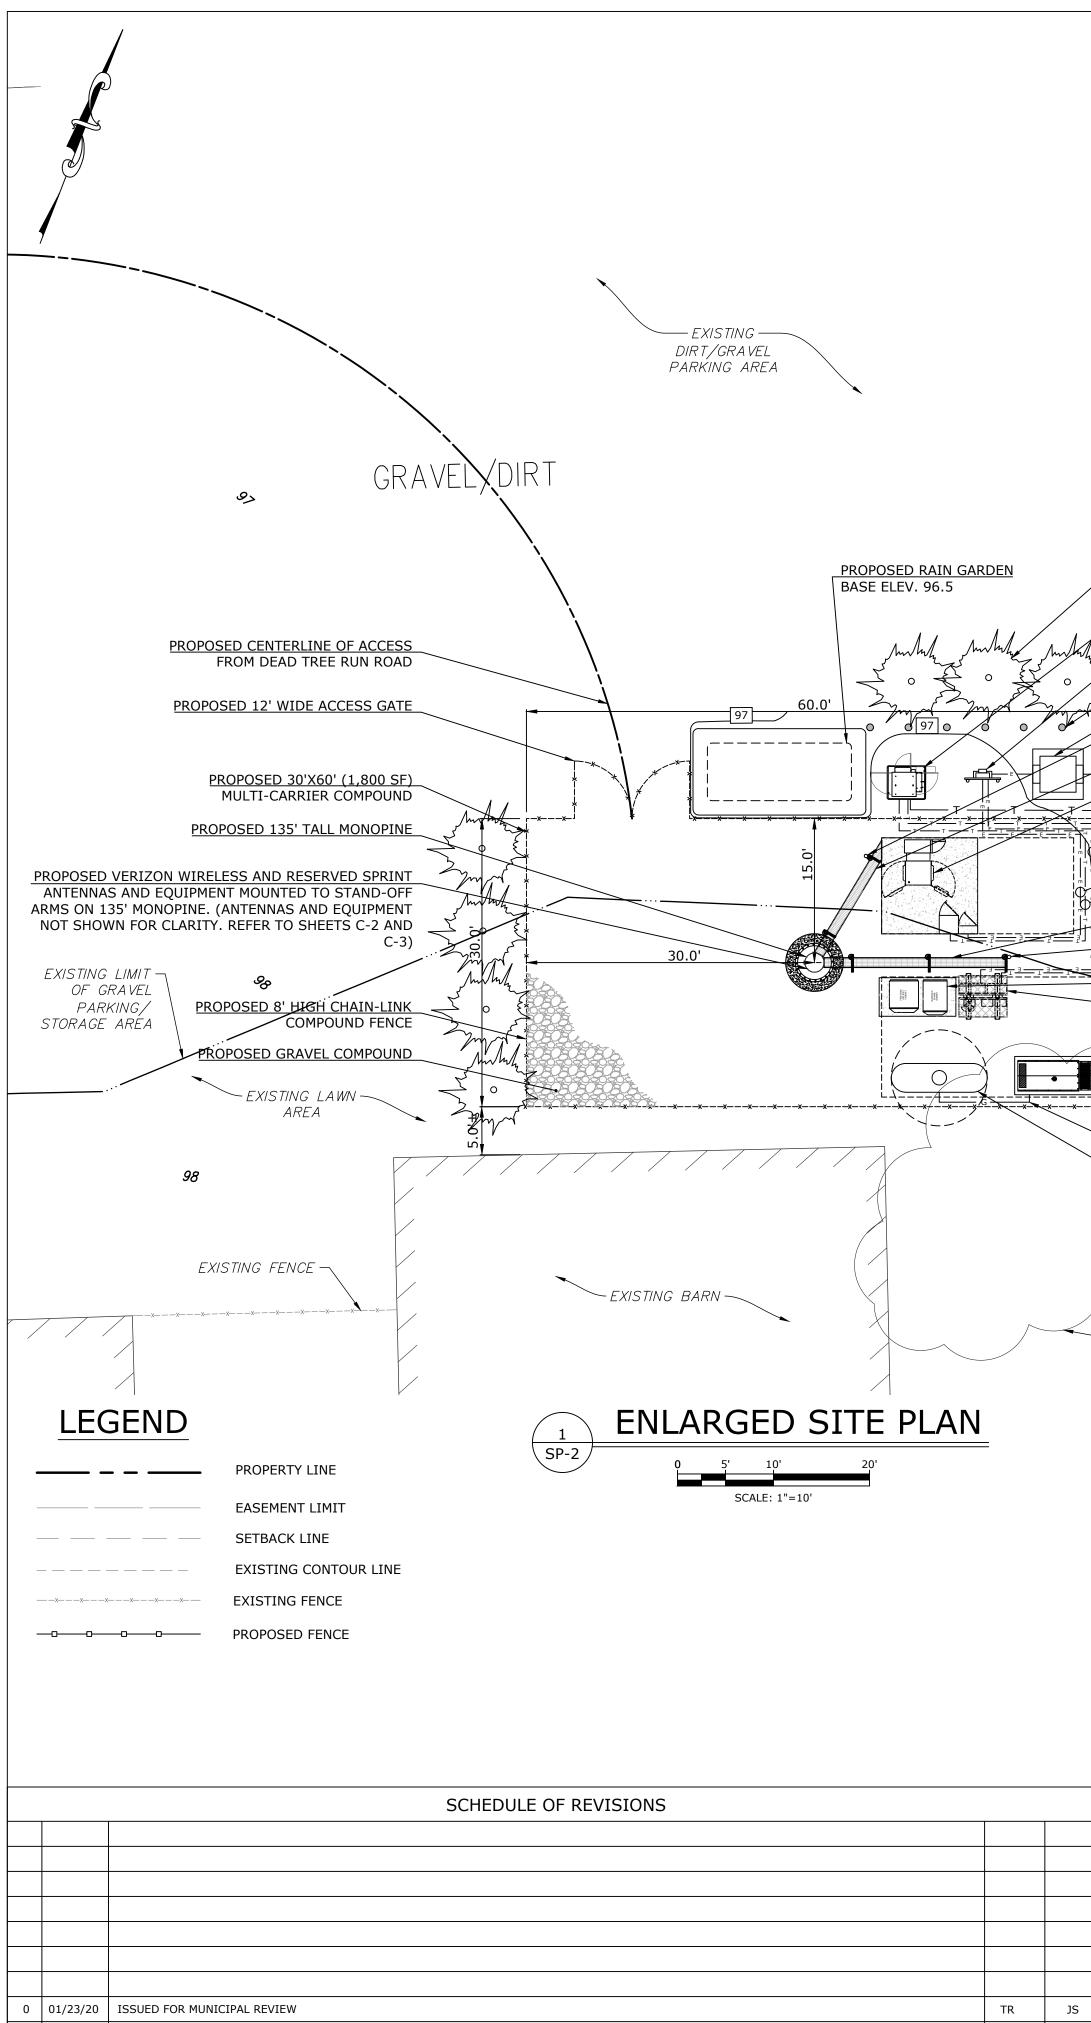



DATE DESCRIPTION OF CHANGES


DRAWN CHK. BY BY


		TOP OF PROPOSED BRANCHING
		♥ ELEV.=140.00'± AGL.
		TOP OF PROPOSED 135' MONOPINE ELEV.=135.00'± AGL.
	– EXISTING LINE OF NON–SEVERABLE EXCEPTION	<u>CENTERLINE OF PROPOSED (9) VERIZON WIRELESS</u> ELEV.=132.00'± AGL.
 ^ 	PROPOSED LANDSCAPING (TYP)	<u>CENTERLINE OF RESERVED (9)</u> <u>SPRINT ANTENNAS</u> ELEV.=122.00'± AGL.
	PROPOSED MESA CABINET PROPOSED METER BANK	CENTERLINE OF FUTURE ANTENNAS
\square	ON STANCHION	
	PROPOSED BOLLARDS	
	PROPOSED TRANSFORMER	ONTHONNAS CENTERLINE OF FUTURE ANTENNAS
	RESERVED SPRINT GPS ANTENNA MOUNTED TO CABLE BRIDGE POST	D BRAI
	RESERVED SPRINT CABLE BRIDGE	SOC SECTION OF SECTIONO OF SEC
5.0'±	ON 10'x10' CONCRETE PAD	PROPOS
	PROPOSED 2" UNDERGROUND ELECTRIC AND TELCO CONDUITS ROUTED TO VERIZON WIRELESS LOAD CENTER AND TELCO CABINET	100,
	RESERVED 2" UNDERGROUND ELECTRIC AND TELCO CONDUITS ROUTED TO SPRINT PPC CABINET	
	PROPOSED VERIZON WIRELESS CABLE BRIDGE	
	PROPOSED GPS ANTENNA MOUNTED 8 TO CABLE BRIDGE POST	
	EQUIPMENT CABINETS ON CONC. PAD	
	PROPOSED LOAD CENTER, TELCO CABINET, AND WORKLIGHT MOUNTED TO UNISTRUT H-FRAME BELOW CABLE BRIDGE CANOPY	
T		
	PROPOSED 12'-6"X22'-0" EQUIPMENT EQUIPMENT AREA	
	PROPOSED 30 KW PROPANE	
	GENERATOR	START OF PROPOSED BRANCHING
- \ m	PROPOSED GAS PIPE	ELEV.=40.00'± AGL.
		RESERVED SPRINT EQUIPMENT CABINETS ON CONCRETE PAD
¶ m	TANK WITH 5' SPARK RADIUS	PROPOSED VERIZON WIRELESS EQUIPMENT CABINETS
	PROPOSED 2" UNDERGROUND	PROPOSED VERIZON WIRELESS GPS ANTENNA
/ _ 	ELECTRIC AND TELCO CONDUITS FROM EXISTING UTILITY POLE	PROPOSED VERIZON WIRELESS CABLE BRIDGE
\rightarrow		PROPOSED VERIZON WIRELESS 500 GALLON PROPANE TANK ON CONCRETE EQUIPMENT PAD (BEYOND)
	EXISTING TREES	PROPOSED VERIZON WIRELEES LOAD CENTER AND TELCO BOX ON UNISTRUT H-FRAME UNDER CABLE BRIDGE CANOPY
		RESERVED SPRINT PPC CABINET AND LOAD CENTER
		PROPOSED METER BANK ON STANCHION PROPOSED VERIZON WIRELESS 30KW PROPANE GENERATOR
		TRUFUSED VERIZUN WIRELESS SUNW PRUPANE GENERATUR

PROPOSED TRANSFORMER

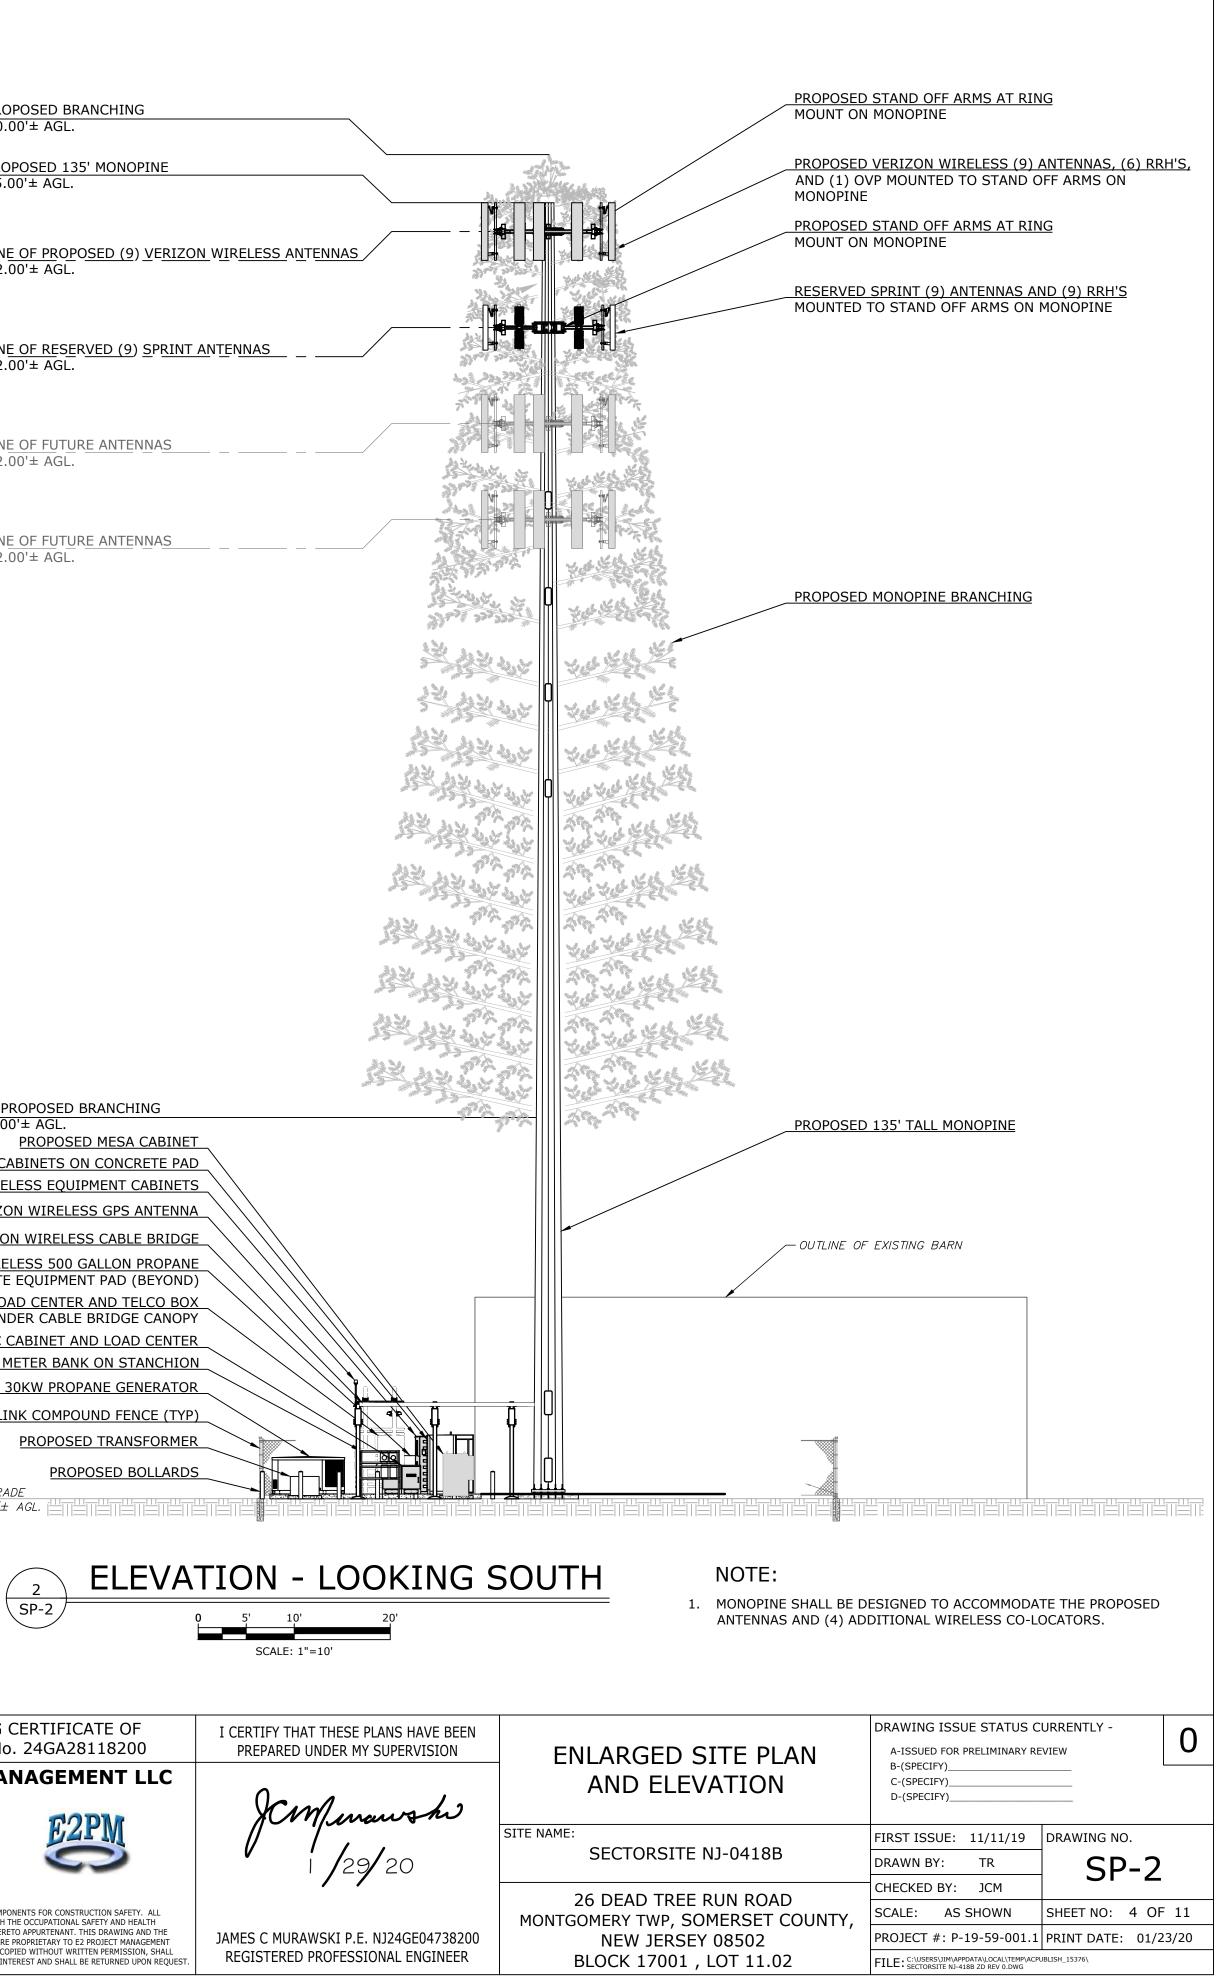

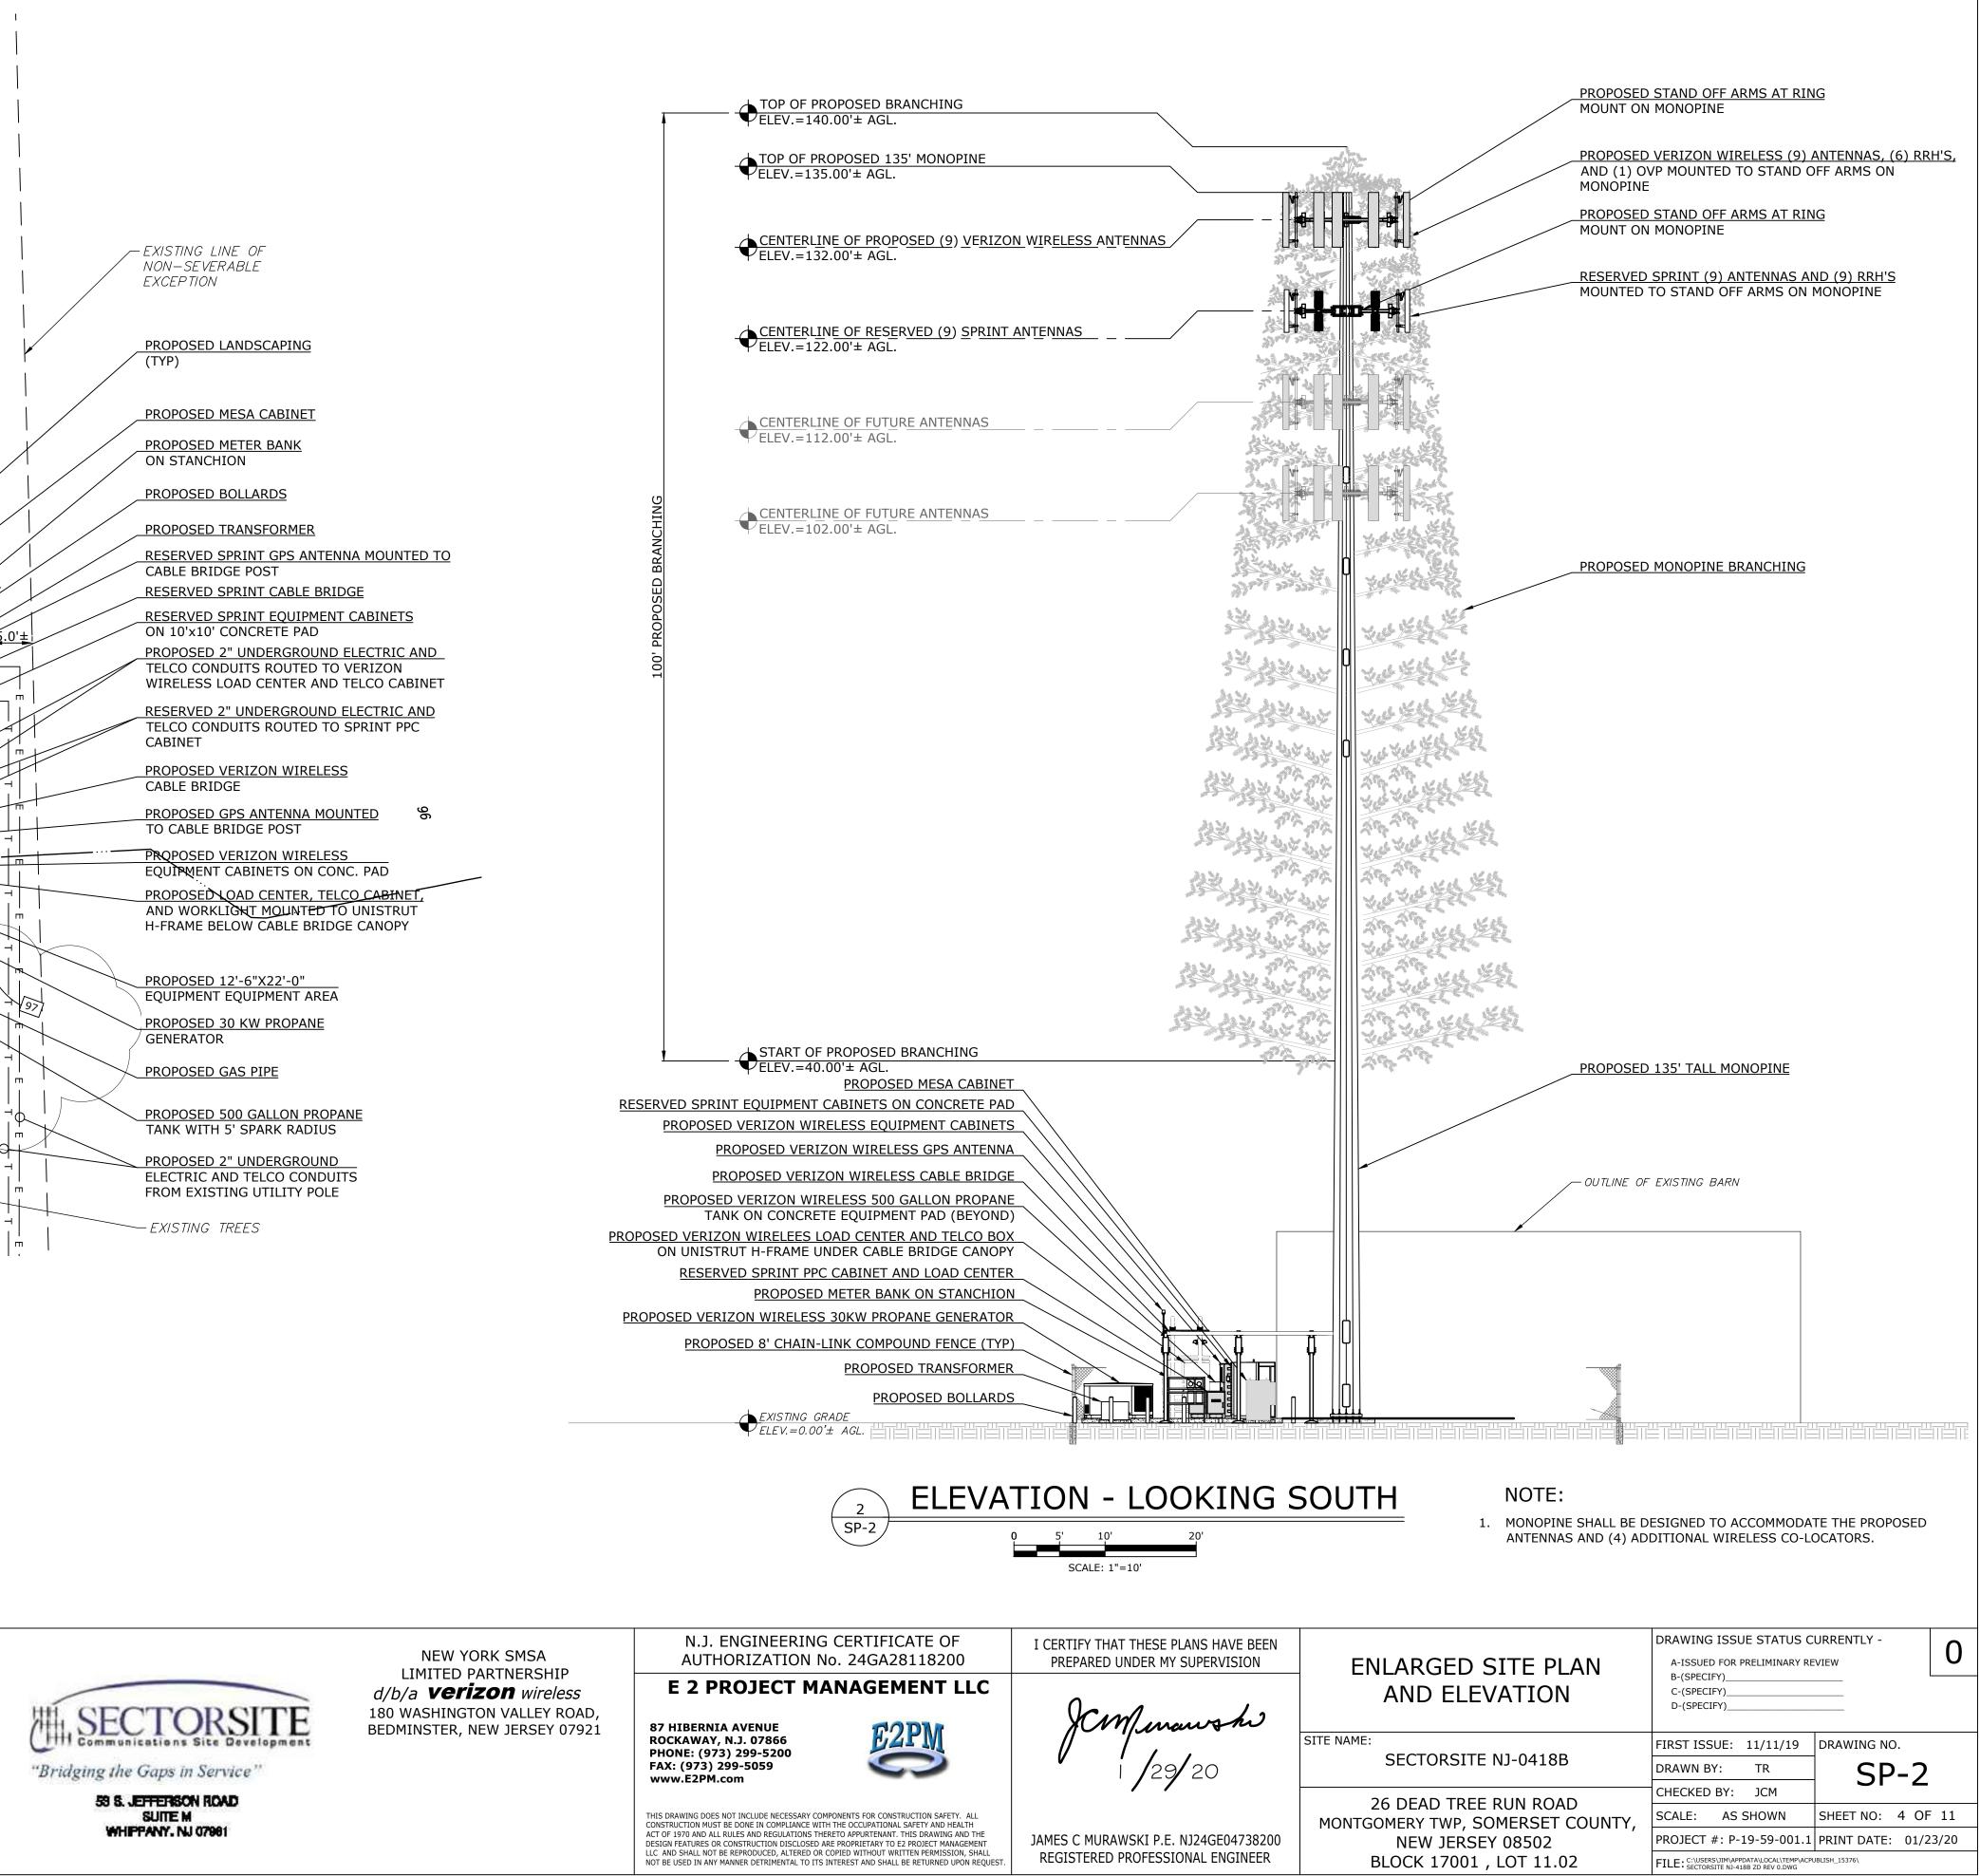


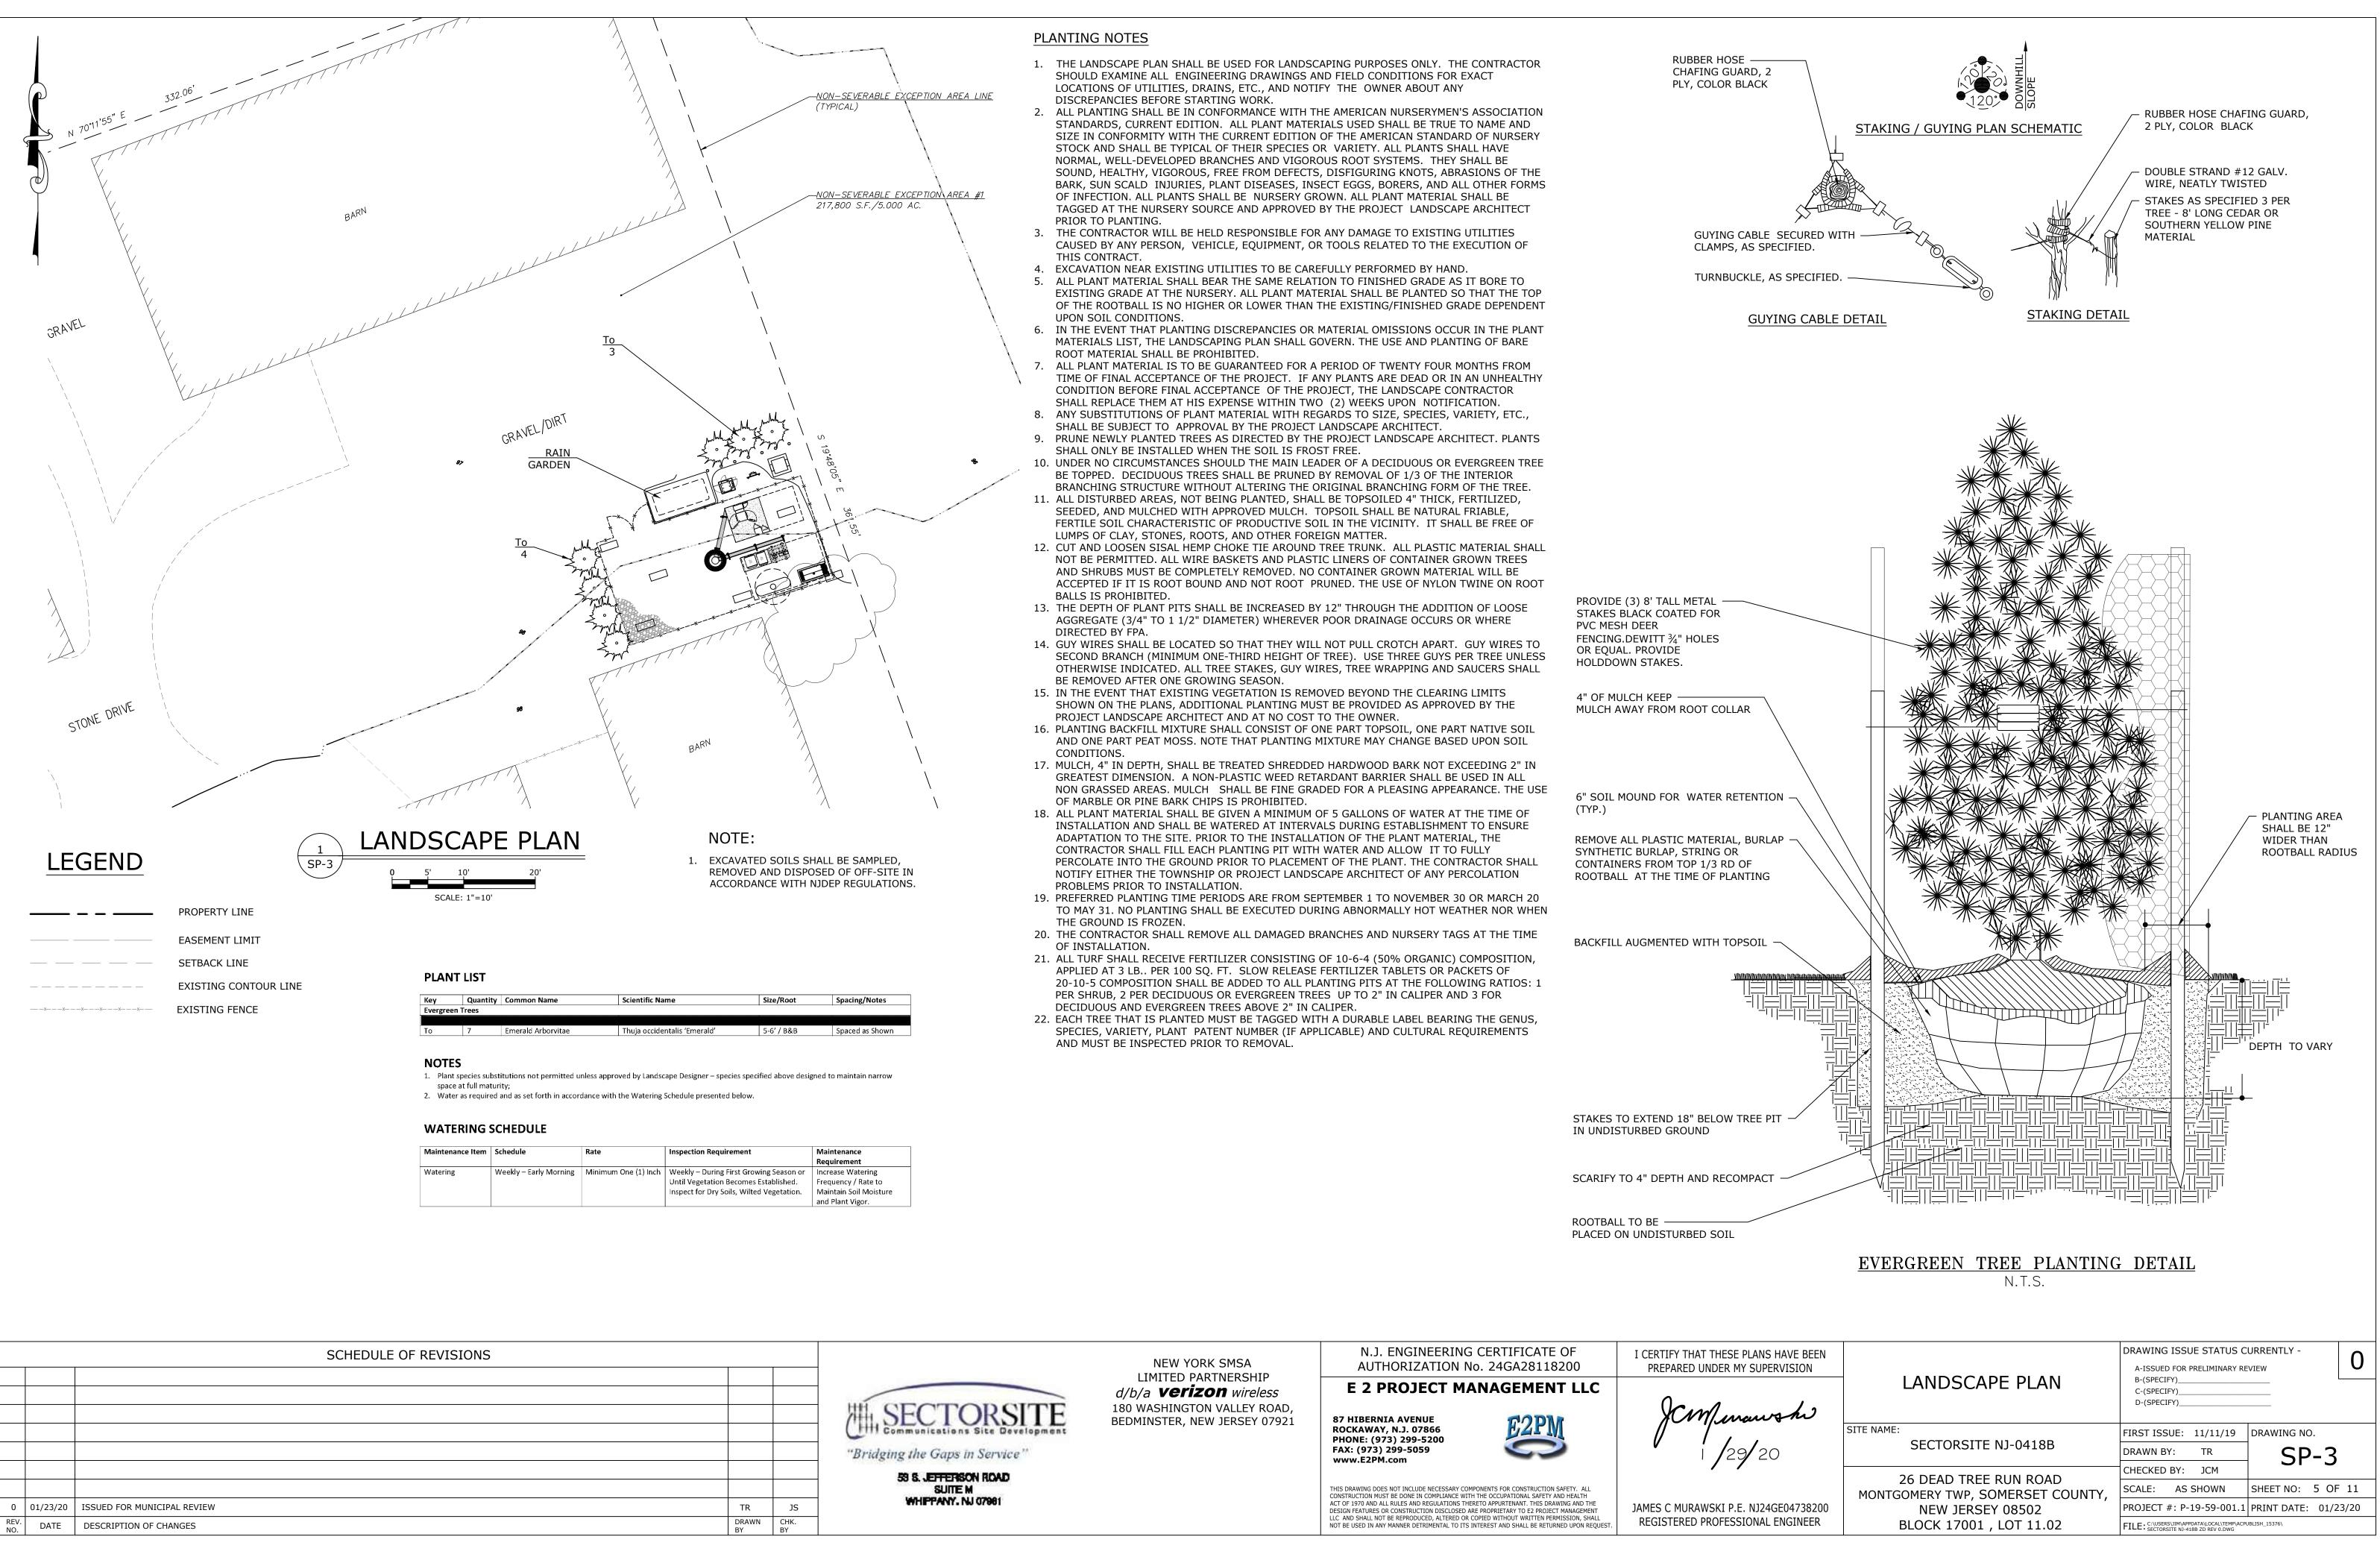

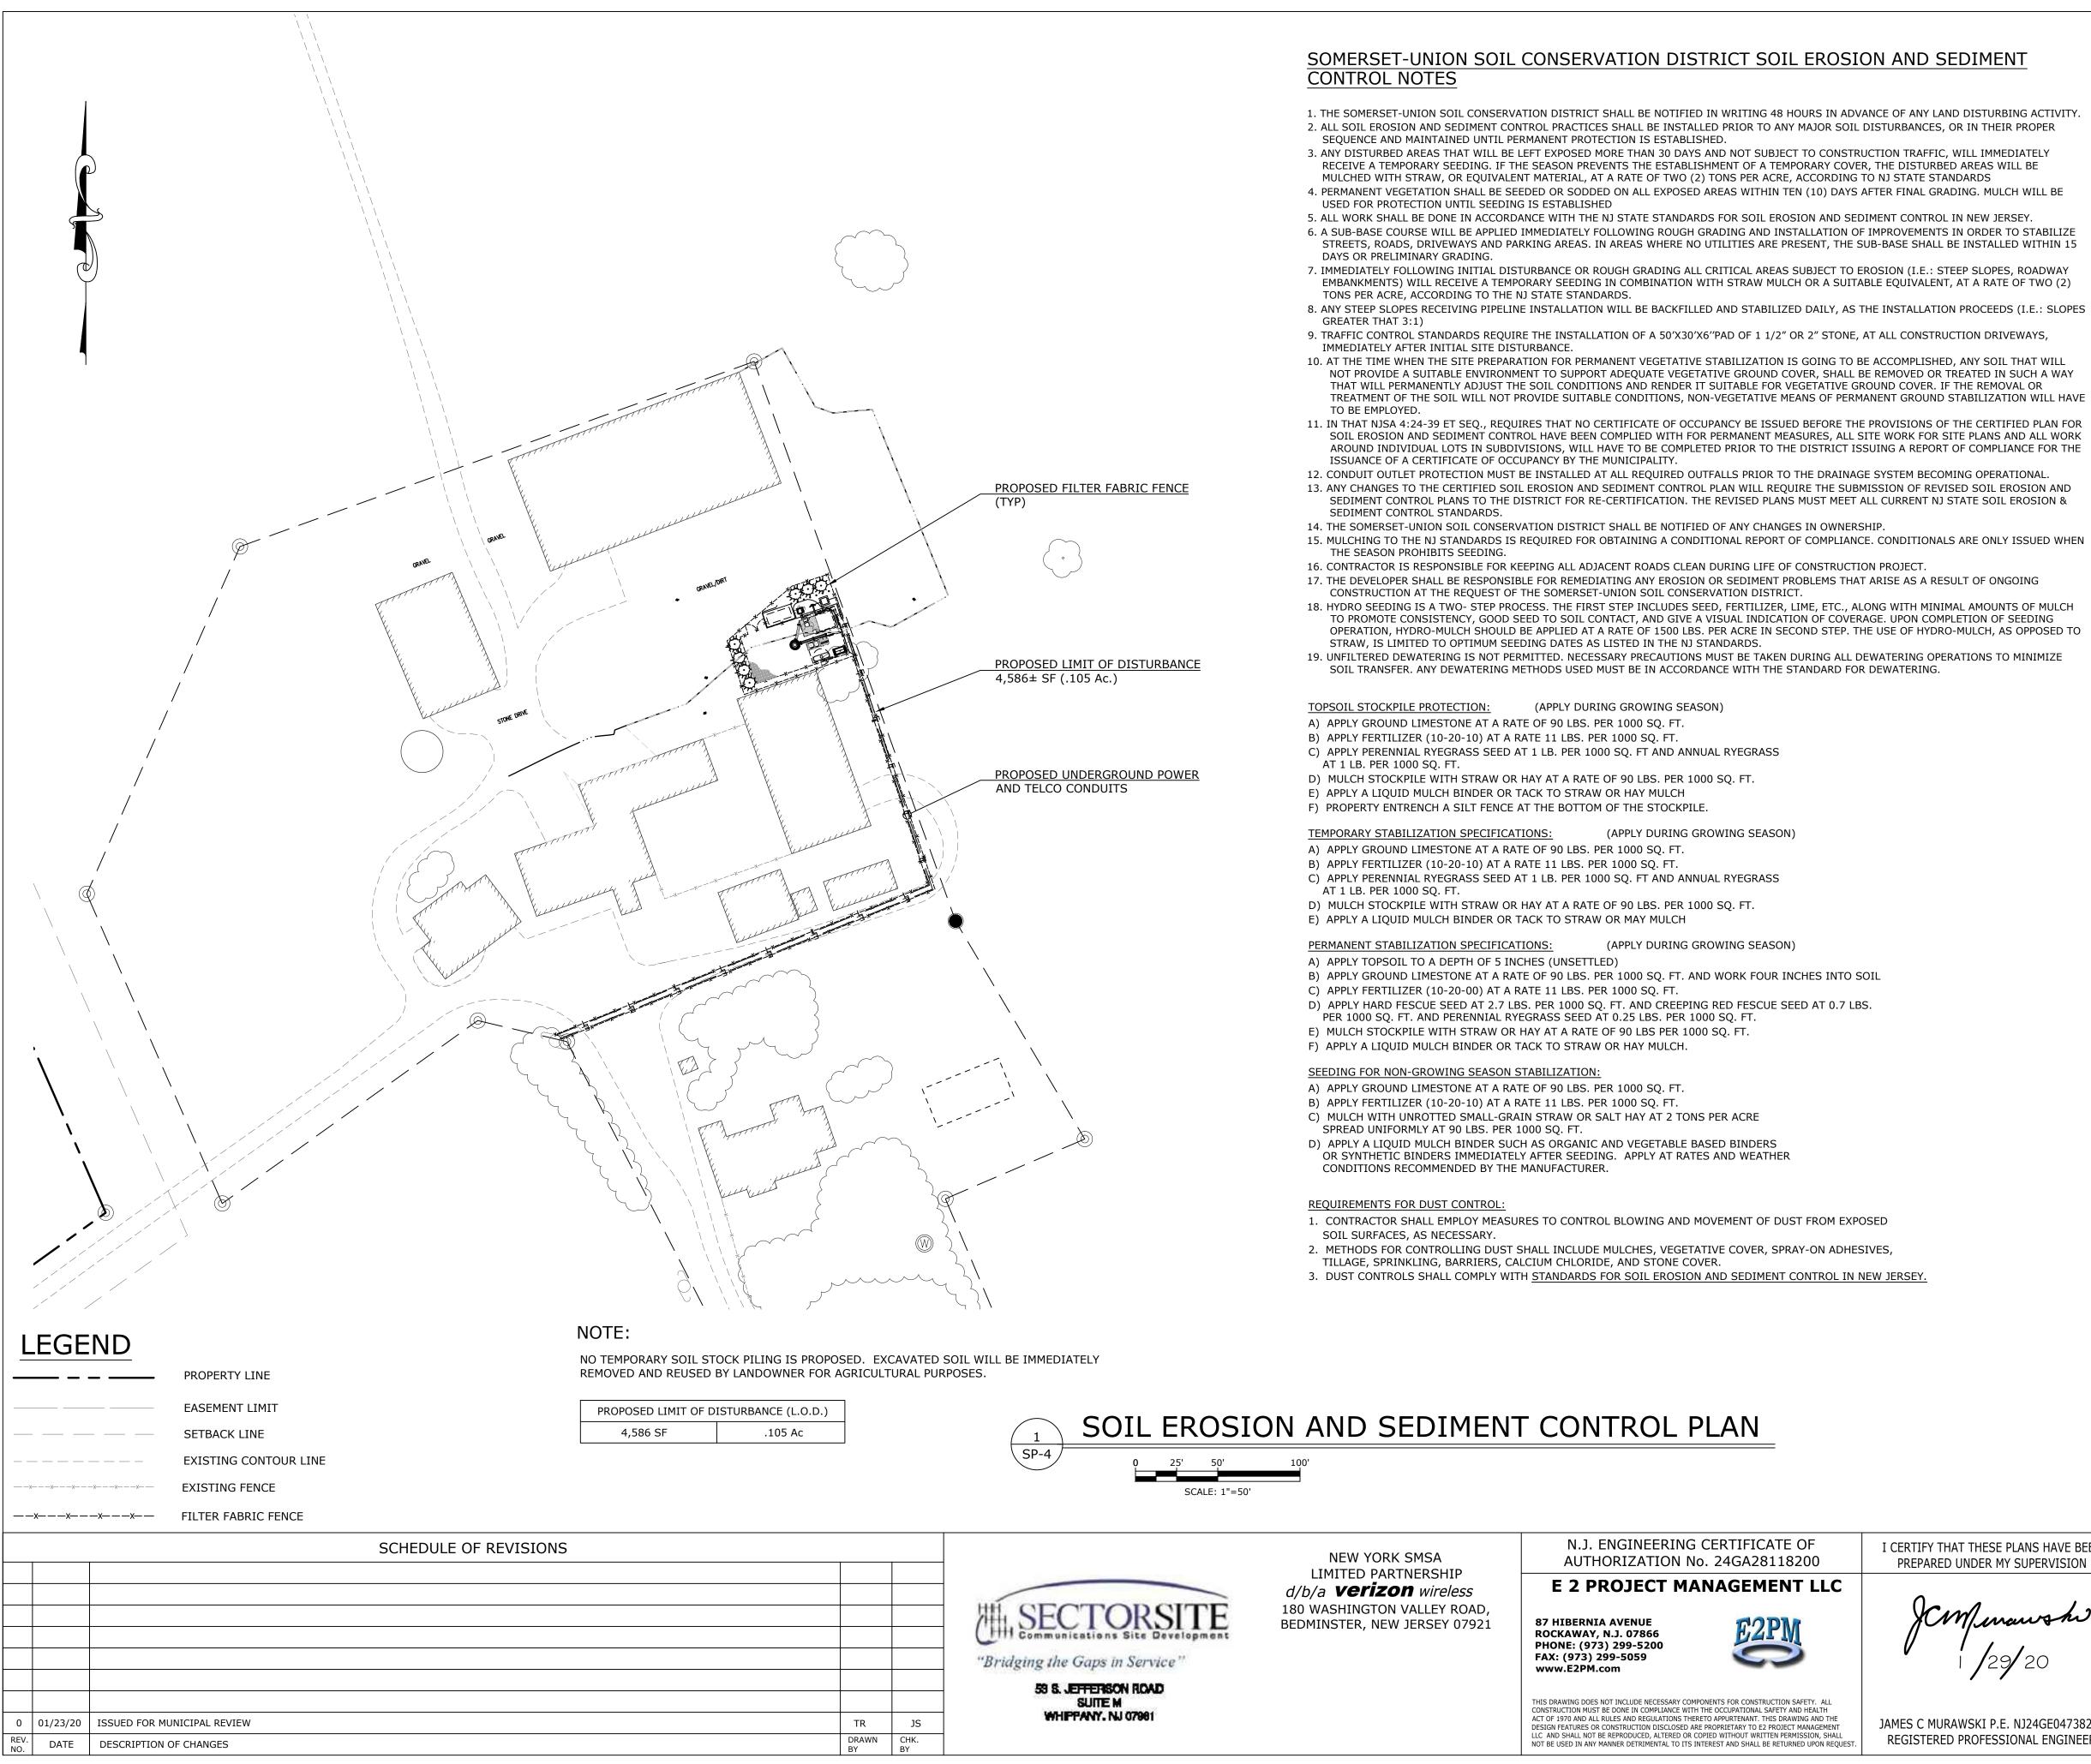

SOMERSET-UNION SOIL CONSERVATION DISTRICT SOIL EROSION AND SEDIMENT

- 1. THE SOMERSET-UNION SOIL CONSERVATION DISTRICT SHALL BE NOTIFIED IN WRITING 48 HOURS IN ADVANCE OF ANY LAND DISTURBING ACTIVITY. 2. ALL SOIL EROSION AND SEDIMENT CONTROL PRACTICES SHALL BE INSTALLED PRIOR TO ANY MAJOR SOIL DISTURBANCES, OR IN THEIR PROPER
- 3. ANY DISTURBED AREAS THAT WILL BE LEFT EXPOSED MORE THAN 30 DAYS AND NOT SUBJECT TO CONSTRUCTION TRAFFIC, WILL IMMEDIATELY RECEIVE A TEMPORARY SEEDING. IF THE SEASON PREVENTS THE ESTABLISHMENT OF A TEMPORARY COVER, THE DISTURBED AREAS WILL BE
- 4. PERMANENT VEGETATION SHALL BE SEEDED OR SODDED ON ALL EXPOSED AREAS WITHIN TEN (10) DAYS AFTER FINAL GRADING. MULCH WILL BE 5. ALL WORK SHALL BE DONE IN ACCORDANCE WITH THE NJ STATE STANDARDS FOR SOIL EROSION AND SEDIMENT CONTROL IN NEW JERSEY.
- 6. A SUB-BASE COURSE WILL BE APPLIED IMMEDIATELY FOLLOWING ROUGH GRADING AND INSTALLATION OF IMPROVEMENTS IN ORDER TO STABILIZE STREETS, ROADS, DRIVEWAYS AND PARKING AREAS. IN AREAS WHERE NO UTILITIES ARE PRESENT, THE SUB-BASE SHALL BE INSTALLED WITHIN 15
- EMBANKMENTS) WILL RECEIVE A TEMPORARY SEEDING IN COMBINATION WITH STRAW MULCH OR A SUITABLE EQUIVALENT, AT A RATE OF TWO (2)
- 10. AT THE TIME WHEN THE SITE PREPARATION FOR PERMANENT VEGETATIVE STABILIZATION IS GOING TO BE ACCOMPLISHED, ANY SOIL THAT WILL NOT PROVIDE A SUITABLE ENVIRONMENT TO SUPPORT ADEQUATE VEGETATIVE GROUND COVER, SHALL BE REMOVED OR TREATED IN SUCH A WAY THAT WILL PERMANENTLY ADJUST THE SOIL CONDITIONS AND RENDER IT SUITABLE FOR VEGETATIVE GROUND COVER. IF THE REMOVAL OR TREATMENT OF THE SOIL WILL NOT PROVIDE SUITABLE CONDITIONS, NON-VEGETATIVE MEANS OF PERMANENT GROUND STABILIZATION WILL HAVE
- 11. IN THAT NJSA 4:24-39 ET SEQ., REQUIRES THAT NO CERTIFICATE OF OCCUPANCY BE ISSUED BEFORE THE PROVISIONS OF THE CERTIFIED PLAN FOR SOIL EROSION AND SEDIMENT CONTROL HAVE BEEN COMPLIED WITH FOR PERMANENT MEASURES, ALL SITE WORK FOR SITE PLANS AND ALL WORK AROUND INDIVIDUAL LOTS IN SUBDIVISIONS, WILL HAVE TO BE COMPLETED PRIOR TO THE DISTRICT ISSUING A REPORT OF COMPLIANCE FOR THE
- 12. CONDUIT OUTLET PROTECTION MUST BE INSTALLED AT ALL REQUIRED OUTFALLS PRIOR TO THE DRAINAGE SYSTEM BECOMING OPERATIONAL. 13. ANY CHANGES TO THE CERTIFIED SOIL EROSION AND SEDIMENT CONTROL PLAN WILL REQUIRE THE SUBMISSION OF REVISED SOIL EROSION AND SEDIMENT CONTROL PLANS TO THE DISTRICT FOR RE-CERTIFICATION. THE REVISED PLANS MUST MEET ALL CURRENT NJ STATE SOIL EROSION &
- 15. MULCHING TO THE NJ STANDARDS IS REQUIRED FOR OBTAINING A CONDITIONAL REPORT OF COMPLIANCE. CONDITIONALS ARE ONLY ISSUED WHEN
- 16. CONTRACTOR IS RESPONSIBLE FOR KEEPING ALL ADJACENT ROADS CLEAN DURING LIFE OF CONSTRUCTION PROJECT.
- 18. HYDRO SEEDING IS A TWO- STEP PROCESS. THE FIRST STEP INCLUDES SEED, FERTILIZER, LIME, ETC., ALONG WITH MINIMAL AMOUNTS OF MULCH
- OPERATION, HYDRO-MULCH SHOULD BE APPLIED AT A RATE OF 1500 LBS. PER ACRE IN SECOND STEP. THE USE OF HYDRO-MULCH, AS OPPOSED TO
- SOIL TRANSFER. ANY DEWATERING METHODS USED MUST BE IN ACCORDANCE WITH THE STANDARD FOR DEWATERING.

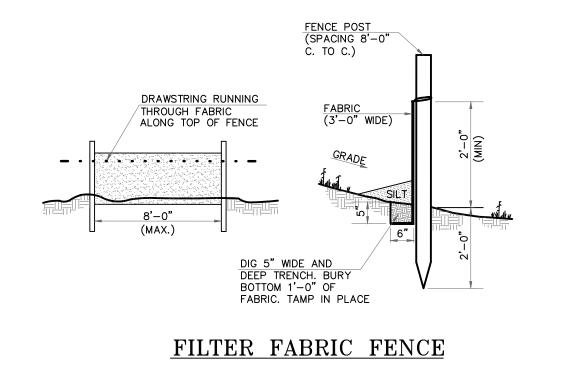



N.T.S.


MAP SURVEY REFERENCE: SITE PLAN INFORMATION WAS OBTAINED FROM "BOUNDARY SURVEY OF BLOCK


17001, LOT 11.02, MONTGOMERY TOWNSHIP, SOMERSET COUNTY, NEW JERSEY" PREPARED BY VanCleef ENGINEERING ASSOCIATES, DATED 10/17/19

HAT THESE PLANS HAVE BEEN ED UNDER MY SUPERVISION	SOIL EROSION AND SEDIMENT CONTROL PLAN,	DRAWING ISSUE STATUS CU A-ISSUED FOR PRELIMINARY REV B-(SPECIFY)	
Menansh	NOTES AND DETAILS	C-(SPECIFY) D-(SPECIFY)	
		FIRST ISSUE: 11/11/19	DRAWING NO.
i /29/20	SECTORSITE NJ-0418B	DRAWN BY: TR	SP-4
	26 DEAD TREE RUN ROAD	CHECKED BY: JCM	
		SCALE: AS SHOWN	SHEET NO: 6 OF 11
IRAWSKI P.E. NJ24GE04738200		PROJECT #: P-19-59-001.1	PRINT DATE: 01/23/20
ED PROFESSIONAL ENGINEER	BLOCK 17001 , LOT 11.02	FILE: C:\USERS\JIM\APPDATA\LOCAL\TEMP\ACPUB SECTORSITE NJ-418B ZD REV 0.DWG	BLISH_15376\

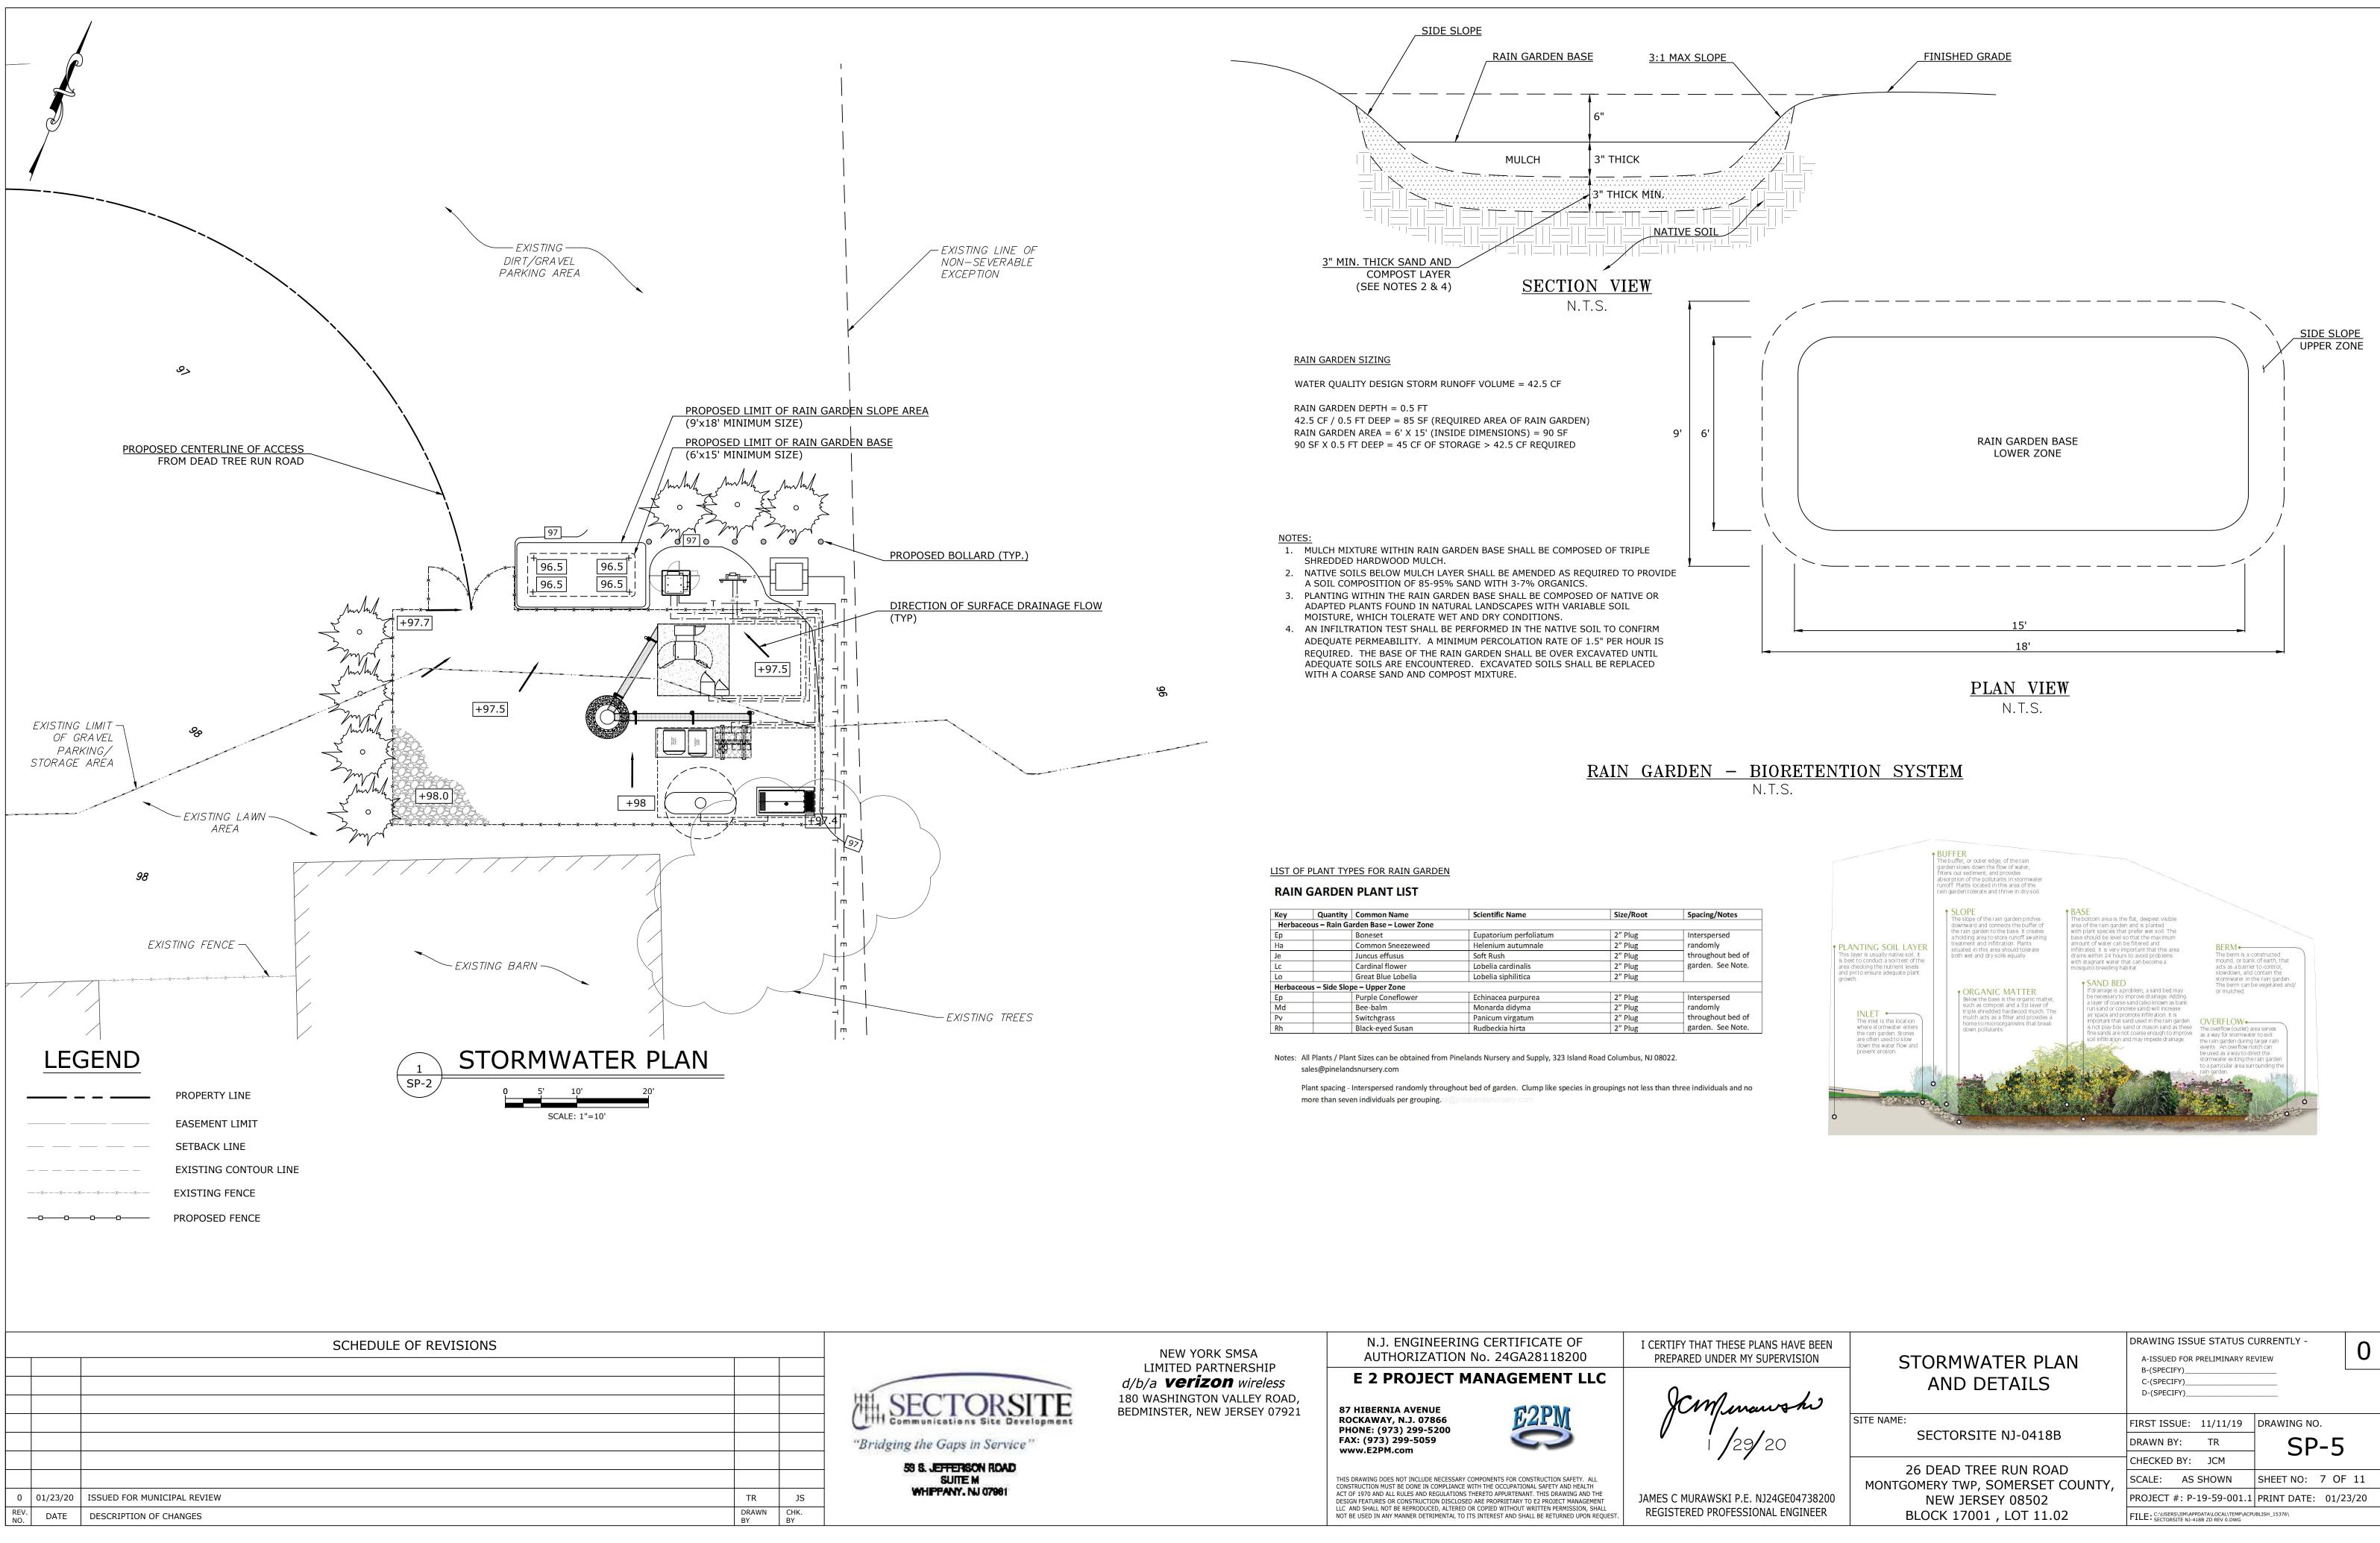

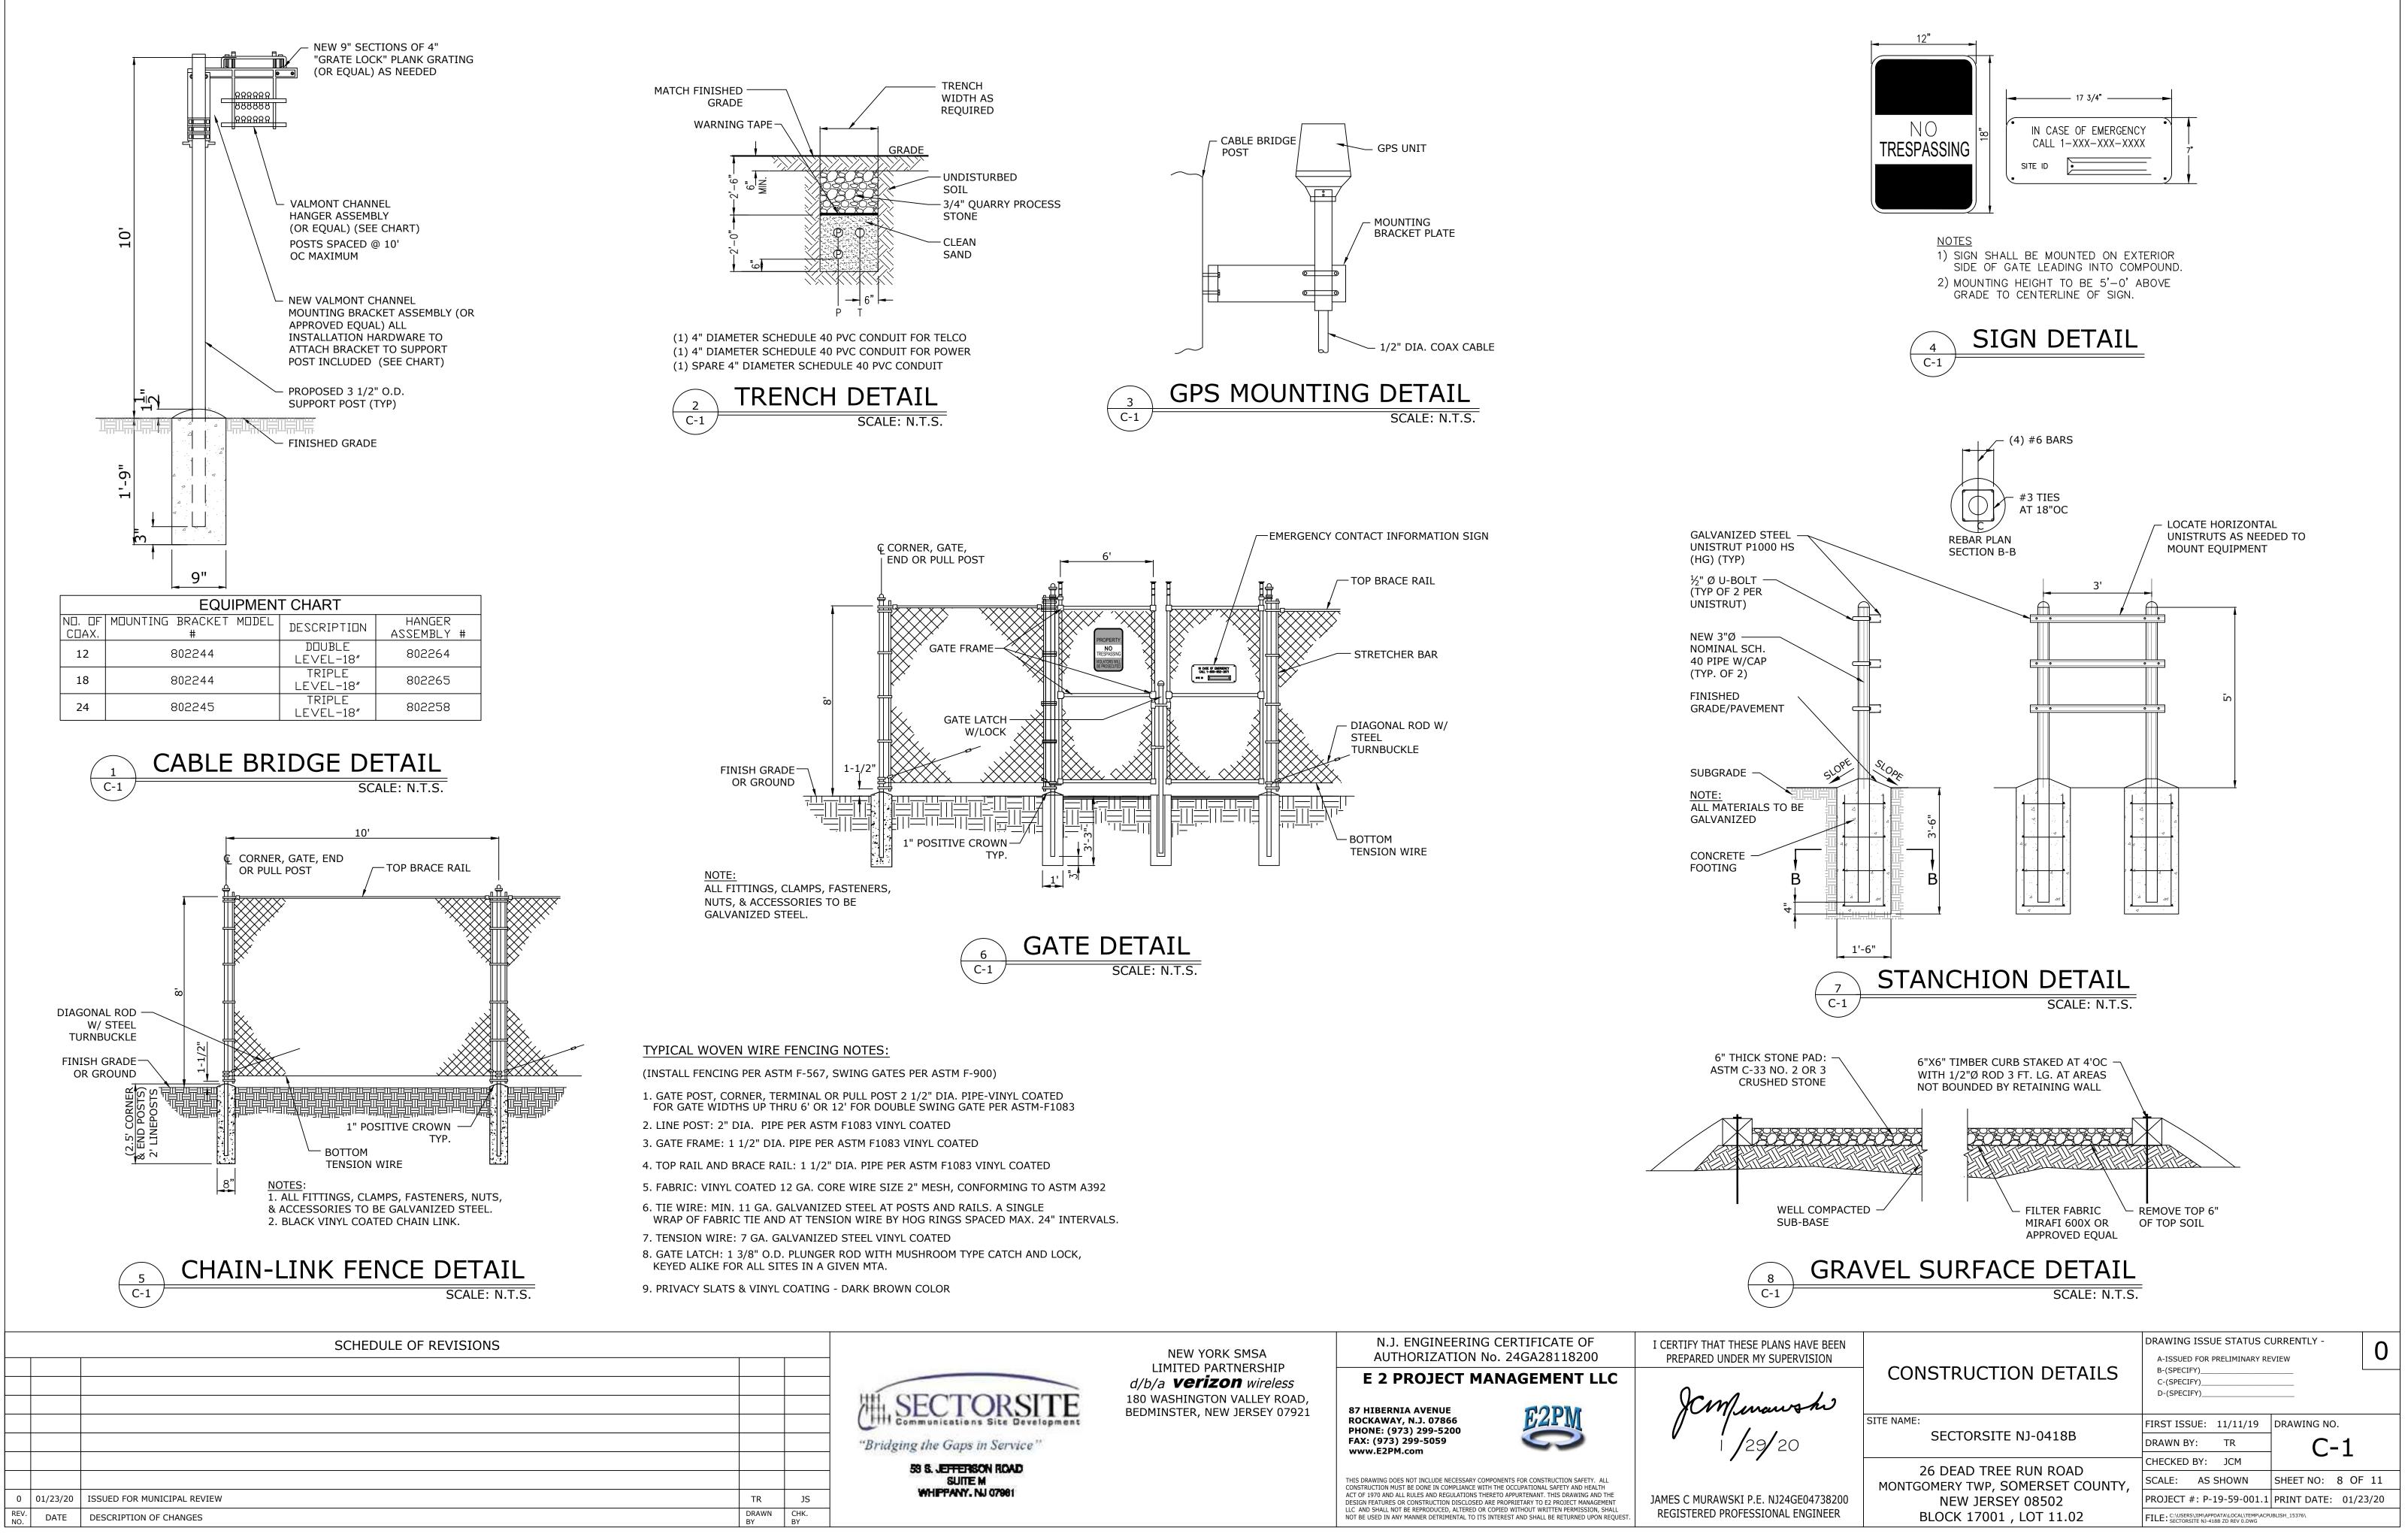


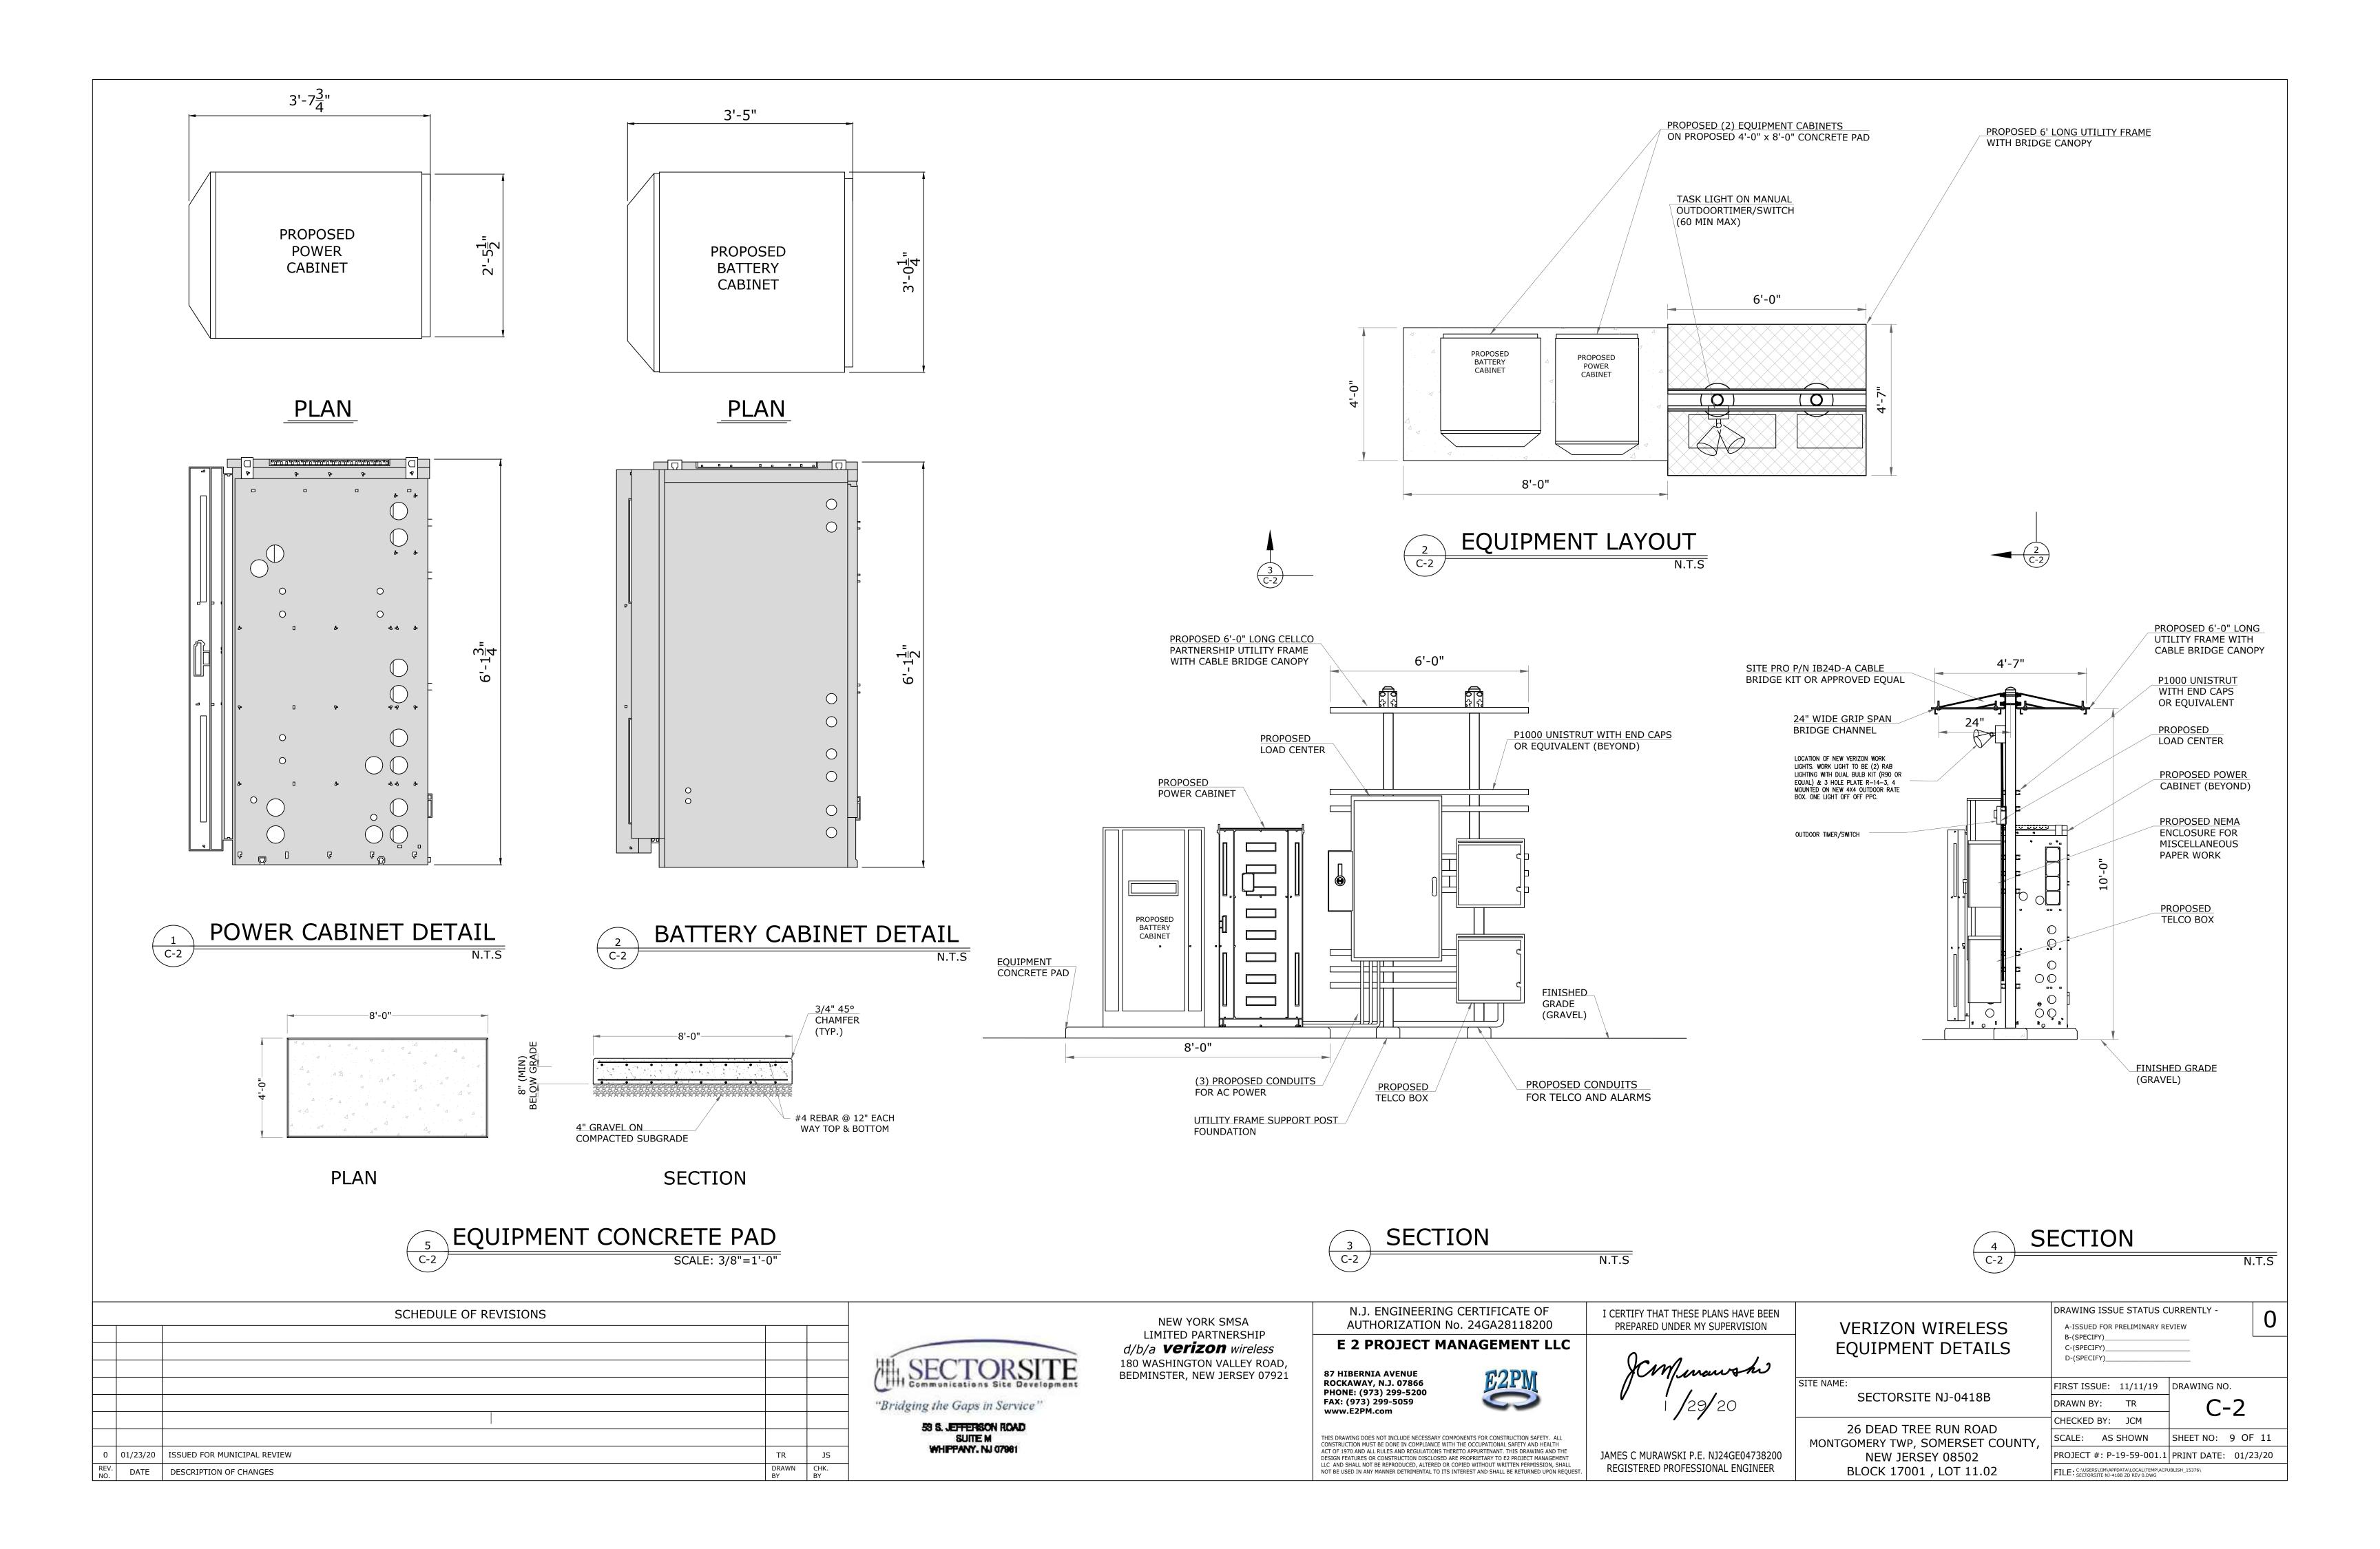


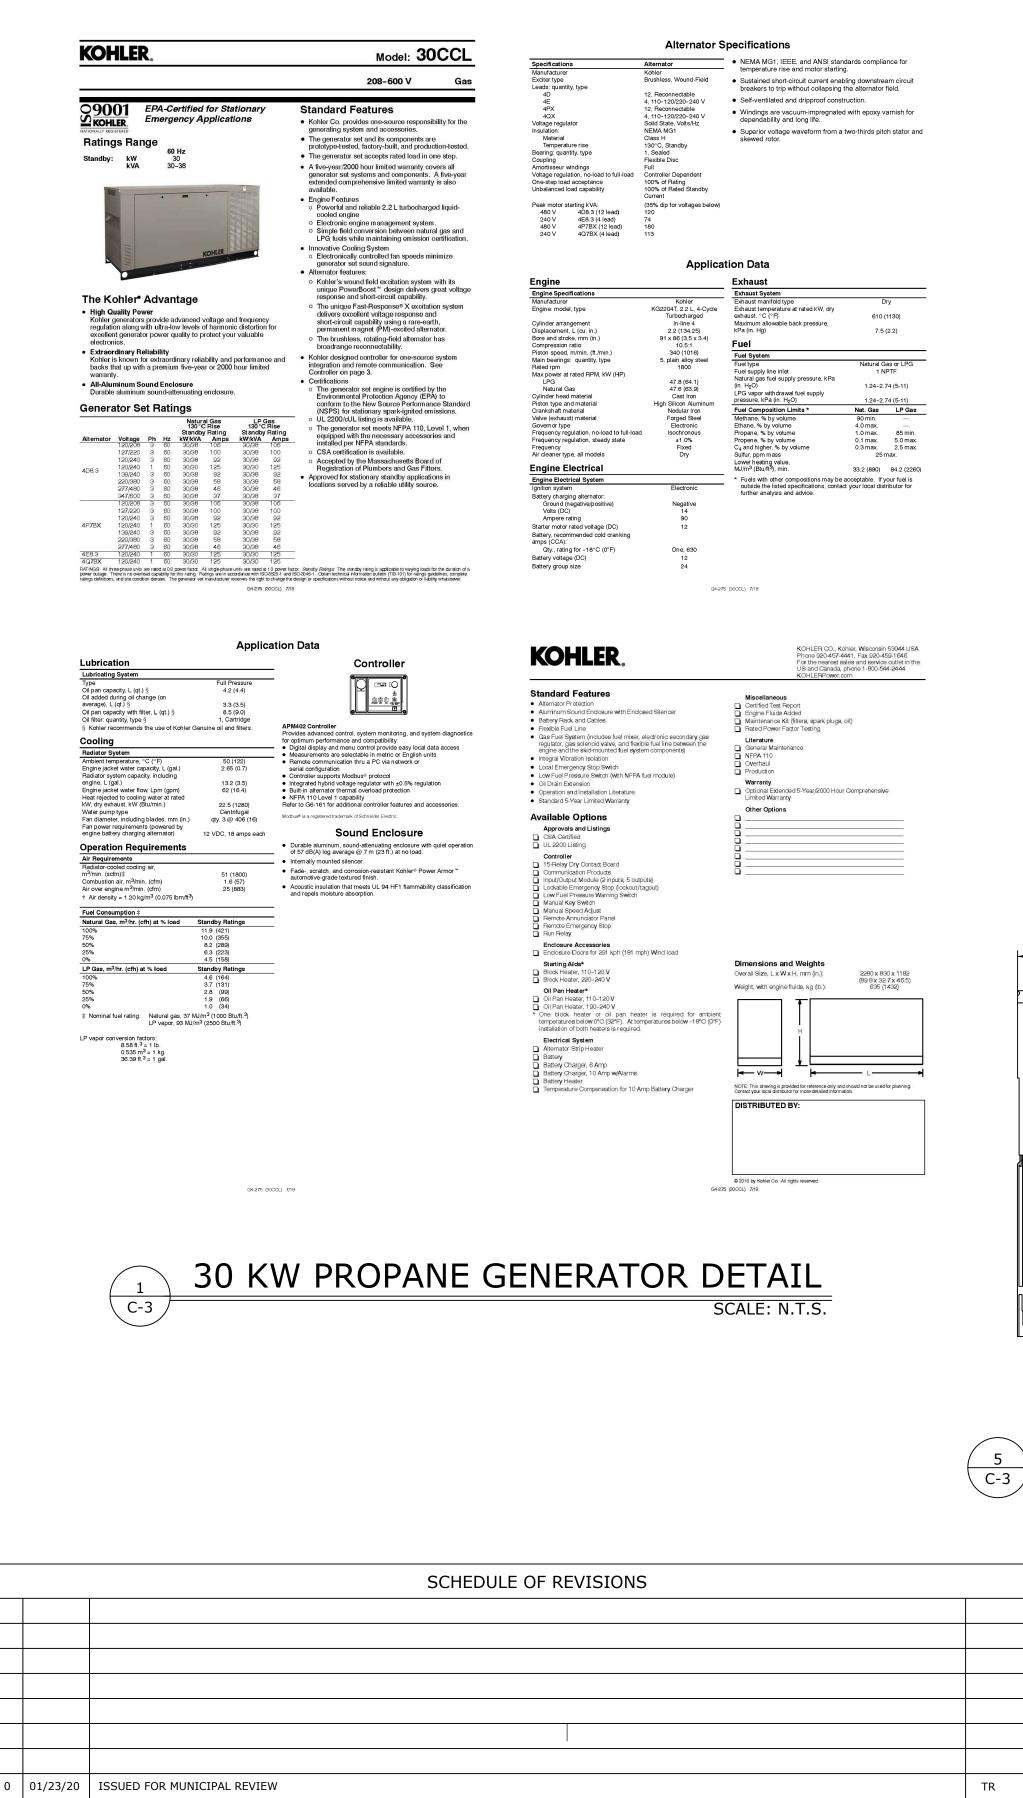

DATE DESCRIPTION OF CHANGES

TR JS DRAWN CHK. BY BY

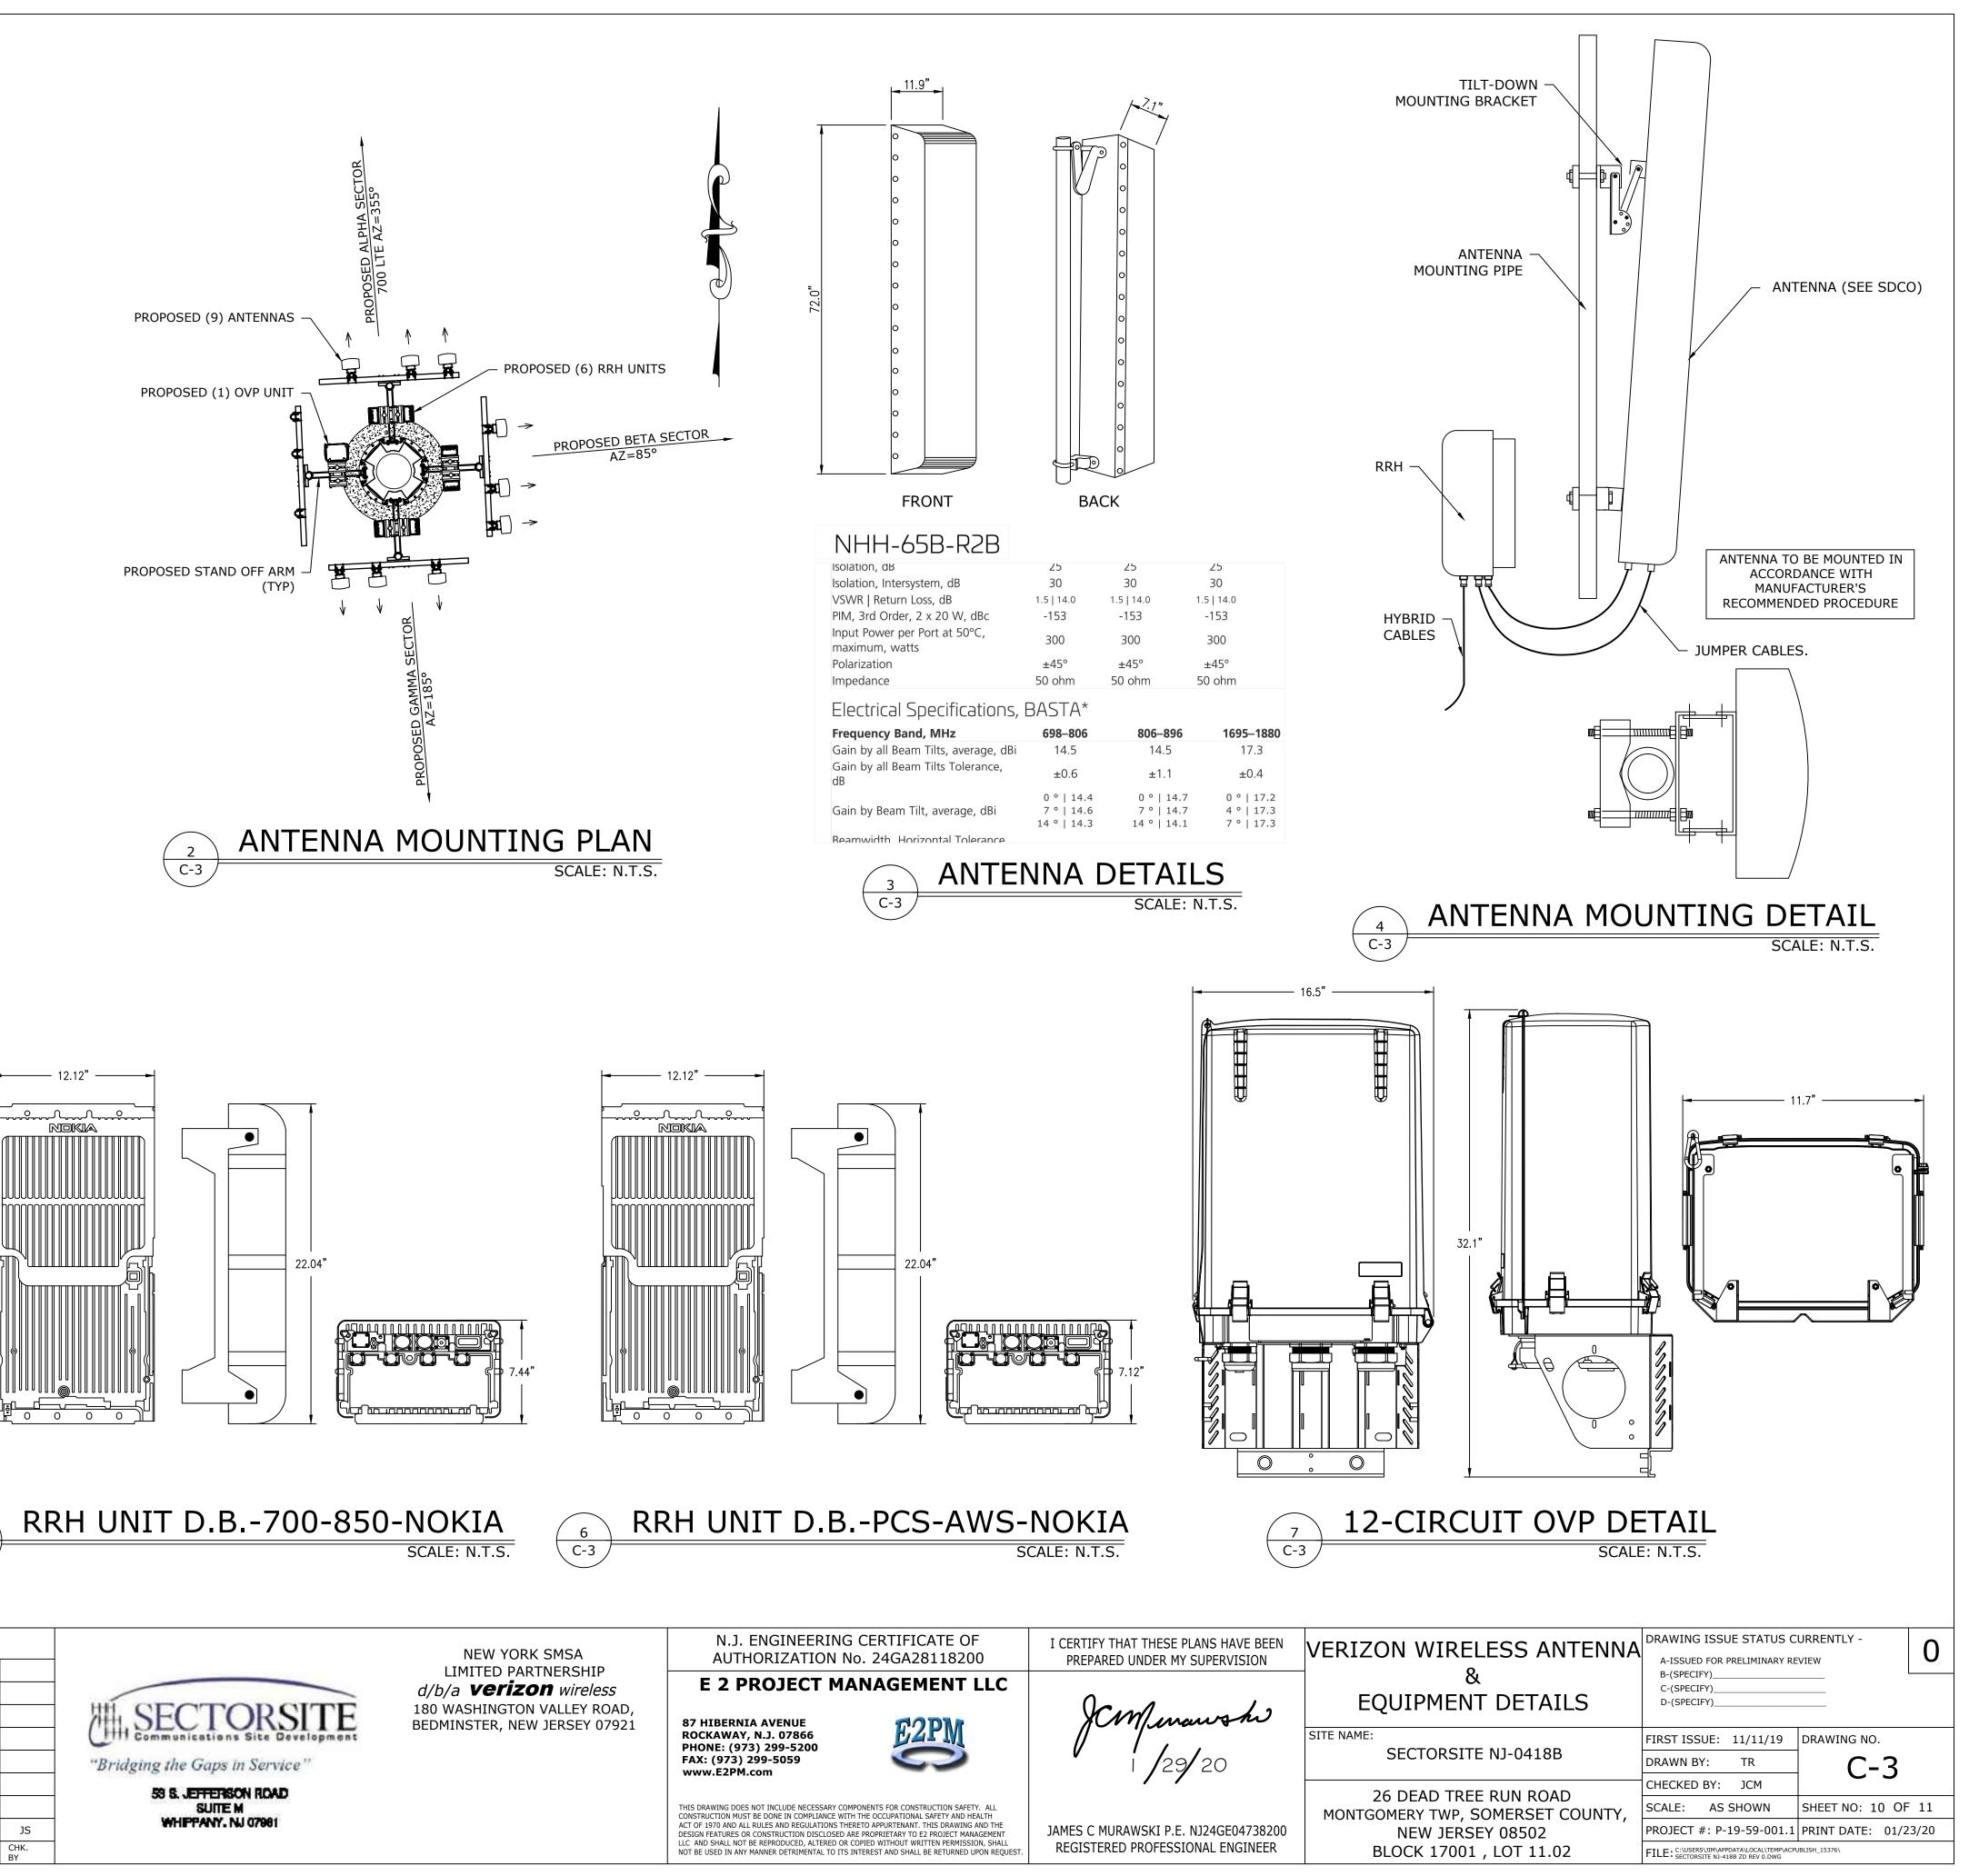

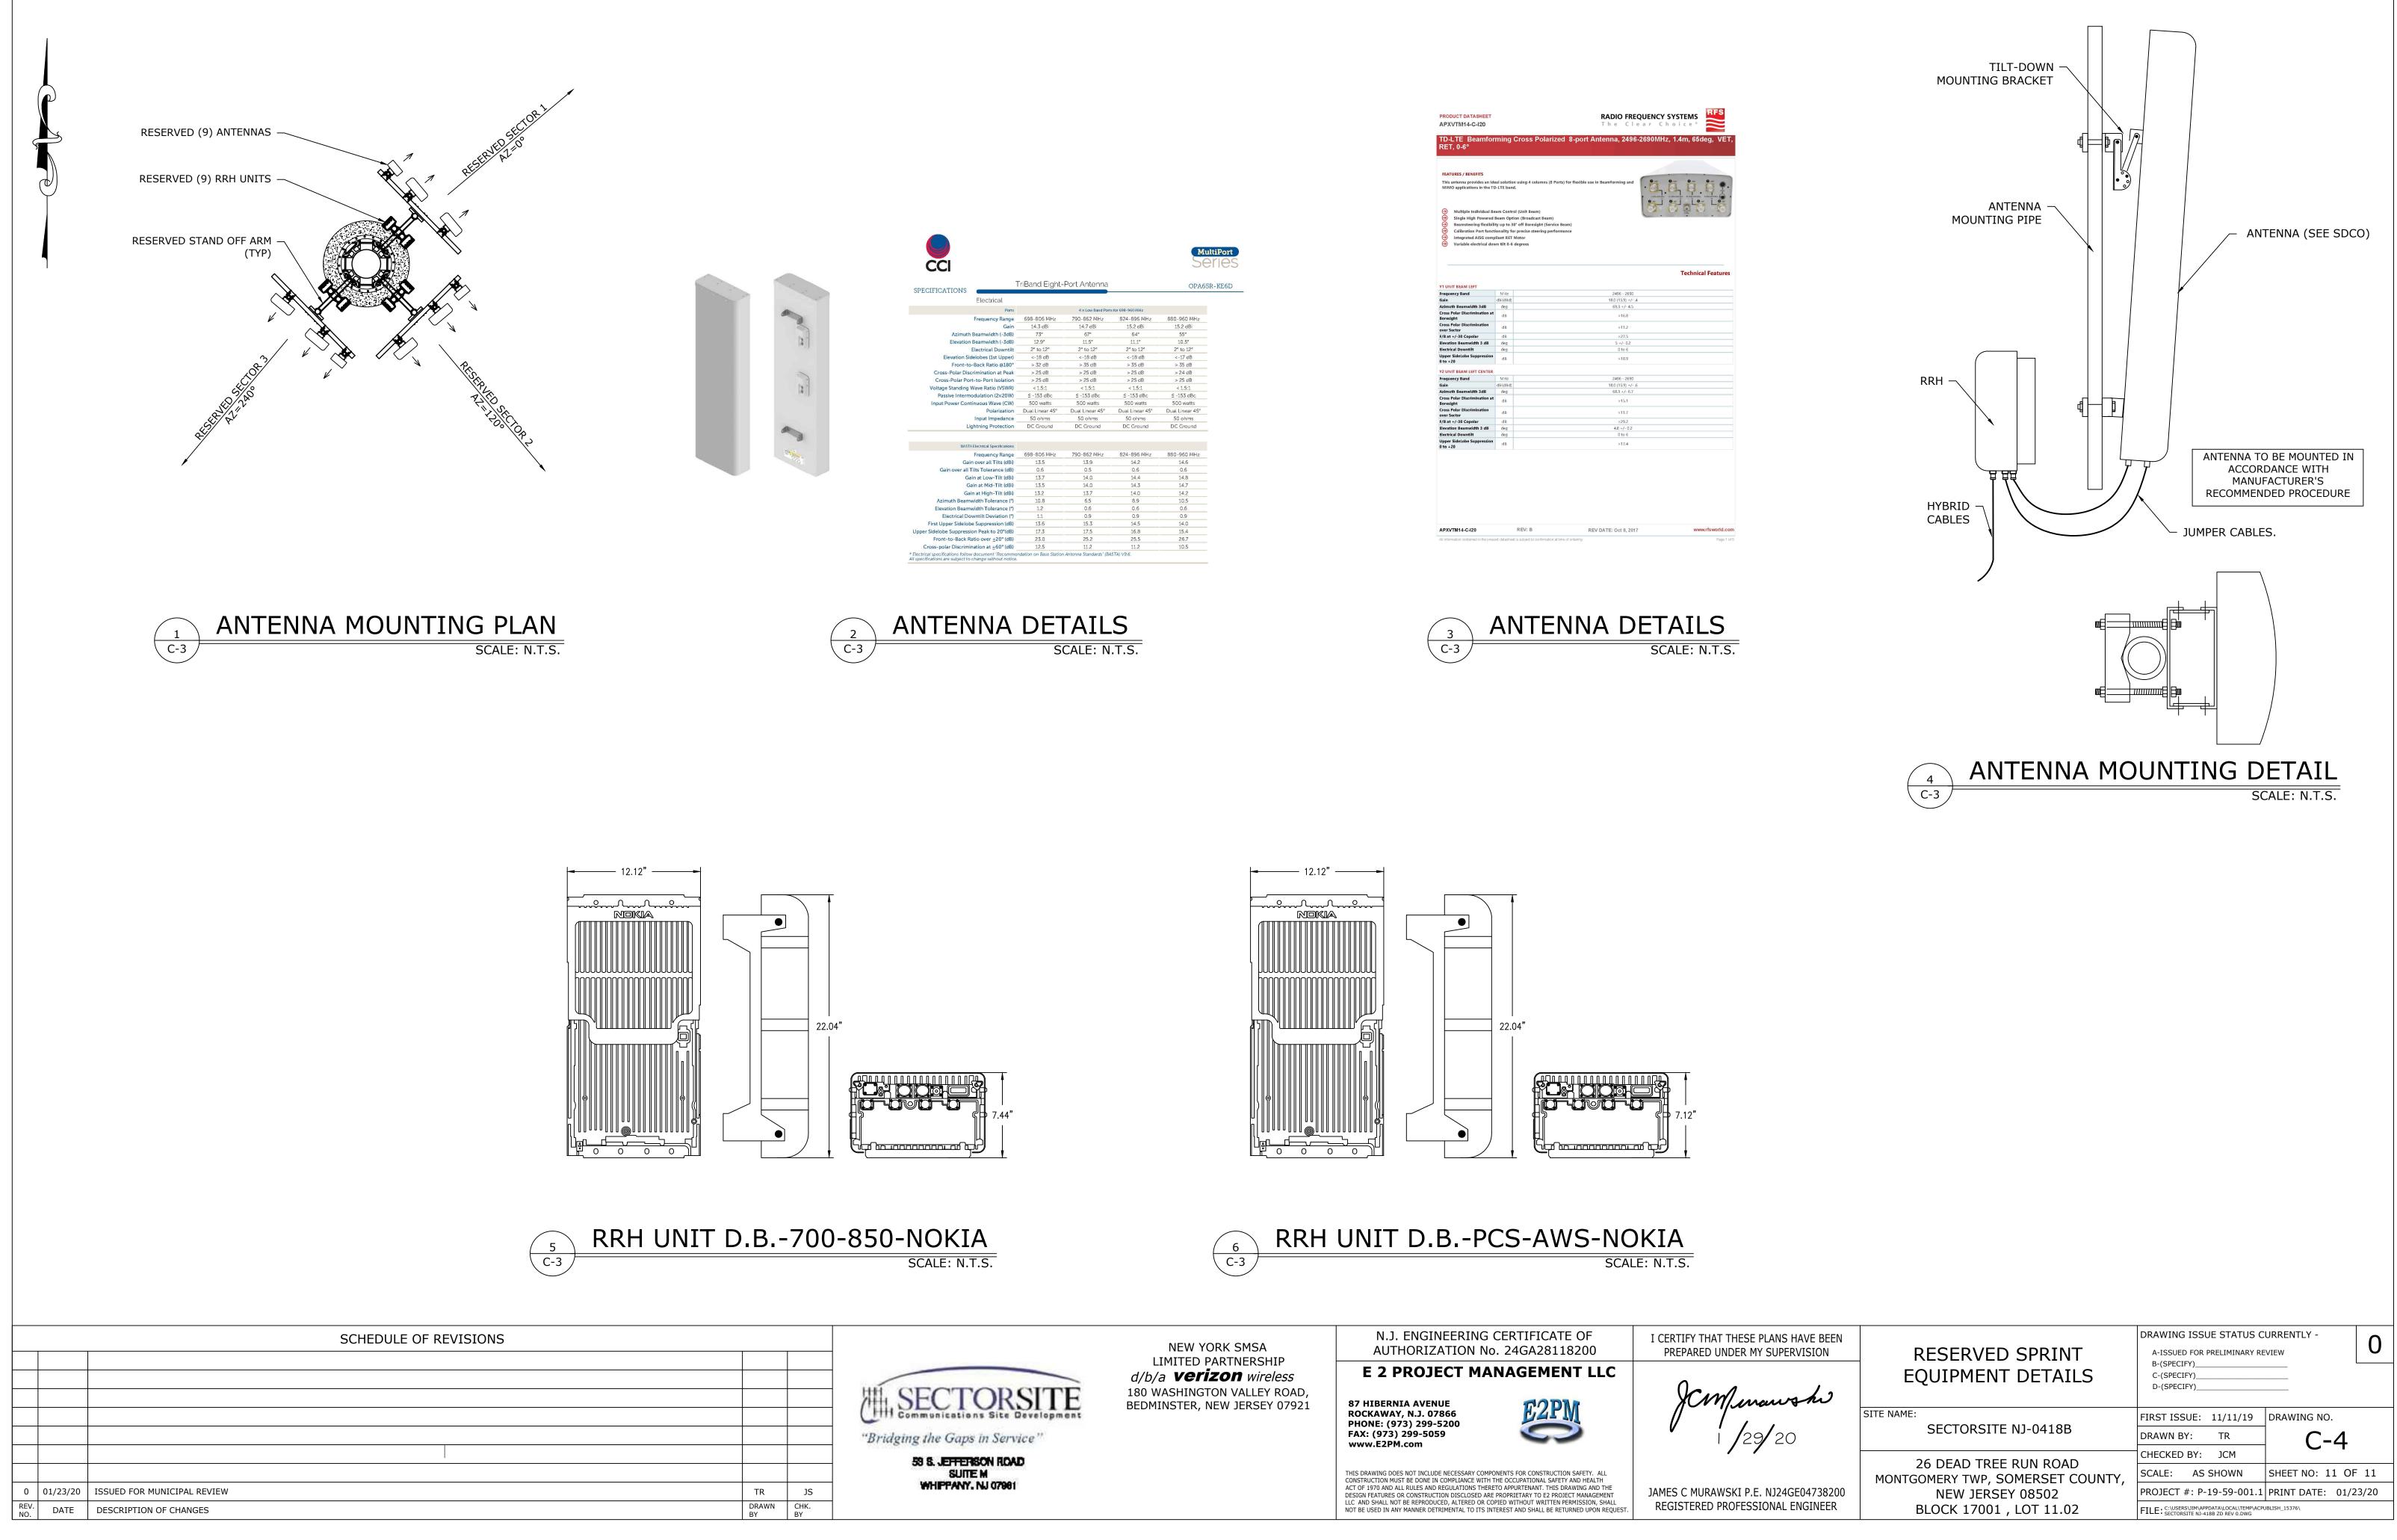

RET, 0-6°			
FEATURES / BENEFITS			(a. a. a.
MIMO applications in the T		n using 4 columns (8 Ports) for flexible use in Beamforming and i.	0, 0, 8
Multiple Individual B	eam Contro	ol (Unit Beam)	
 Multiple Individual B Single High Powered Beamsteering flexibil Calibration Port func Integrated AISG com 			L
Beamsteering flexibil		0° off Boresight (Service Beam)	
 Calibration Port func Integrated AISG com 		r precise steering performance Motor	
 Variable electrical do 			
×			
			Technic
Y1 UNIT BEAM LEFT			
Frequency Band	MHz	2496 - 2690	
Sain	dBi(dBd)	18.0 (15.9) +/4	1
Azimuth Beamwidth 3dB	deg	69.3 +/- 4.5	
Cross Polar Discrimination at	dB	>16.8	
Boresight Cross Polar Discrimination			
over Sector	dB	>11.2	
F/B at +/-30 Copolar	dB	>27.5	
Elevation Beamwidth 3 dB	deg	5 +/- 0.2	
Electrical Downtilt Jpper SideLobe Suppression	deg	0 to 6	
) to +20	dB	>18.9	
2 UNIT BEAM LEFT CENTER			
Frequency Band	MHz	2496 - 2690	
Sain	dBi(dBd)	18.0 (15.9) +/4	5
Azimuth Beamwidth 3dB	deg	68.3 +/- 6.7	
Cross Polar Discrimination at		>15.1	
Boresight Cross Polar Discrimination			
over Sector	dB	>11.7	
F/B at +/-30 Copolar	dB	>29.2	
Elevation Beamwidth 3 dB	deg	4.8 +/- 0.2	
	deg	0 to 6	
Electrical Downtilt Jpper SideLobe Suppression	dB	>17.4	

